




SIDE ELEVATION (GRID LINE B)

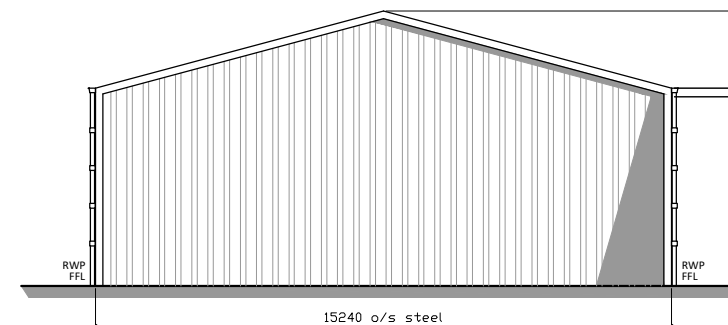


GABLE END (GRID LINE 1)

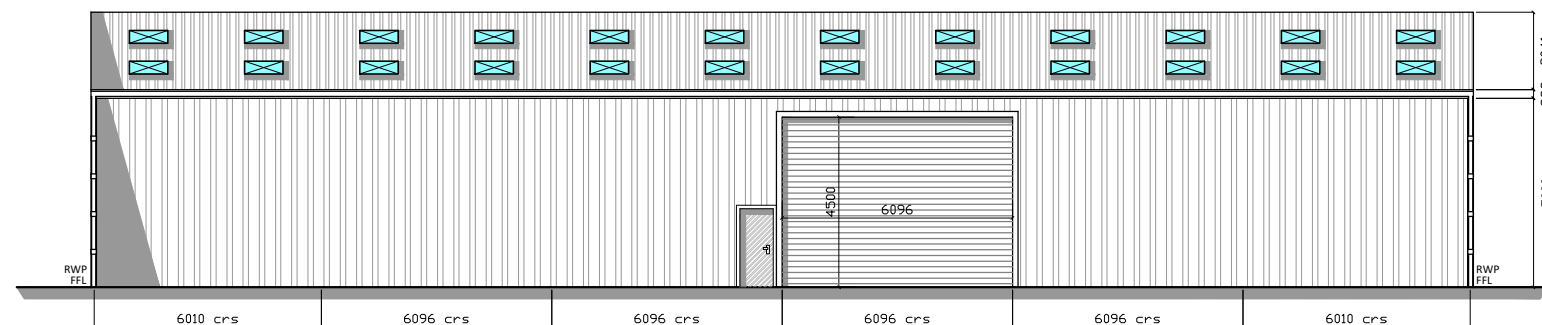

SIDE ELEVATION (GRID LINE A)

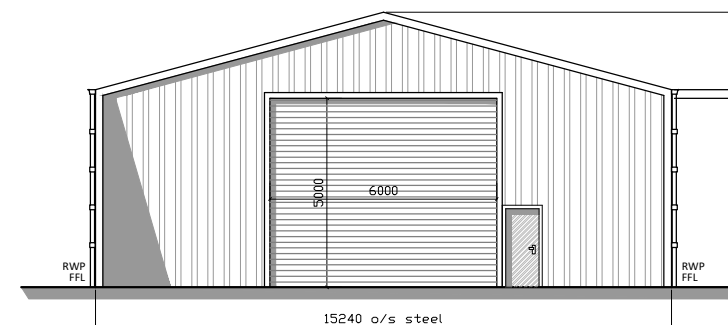


GABLE END (GRID LINE 7)

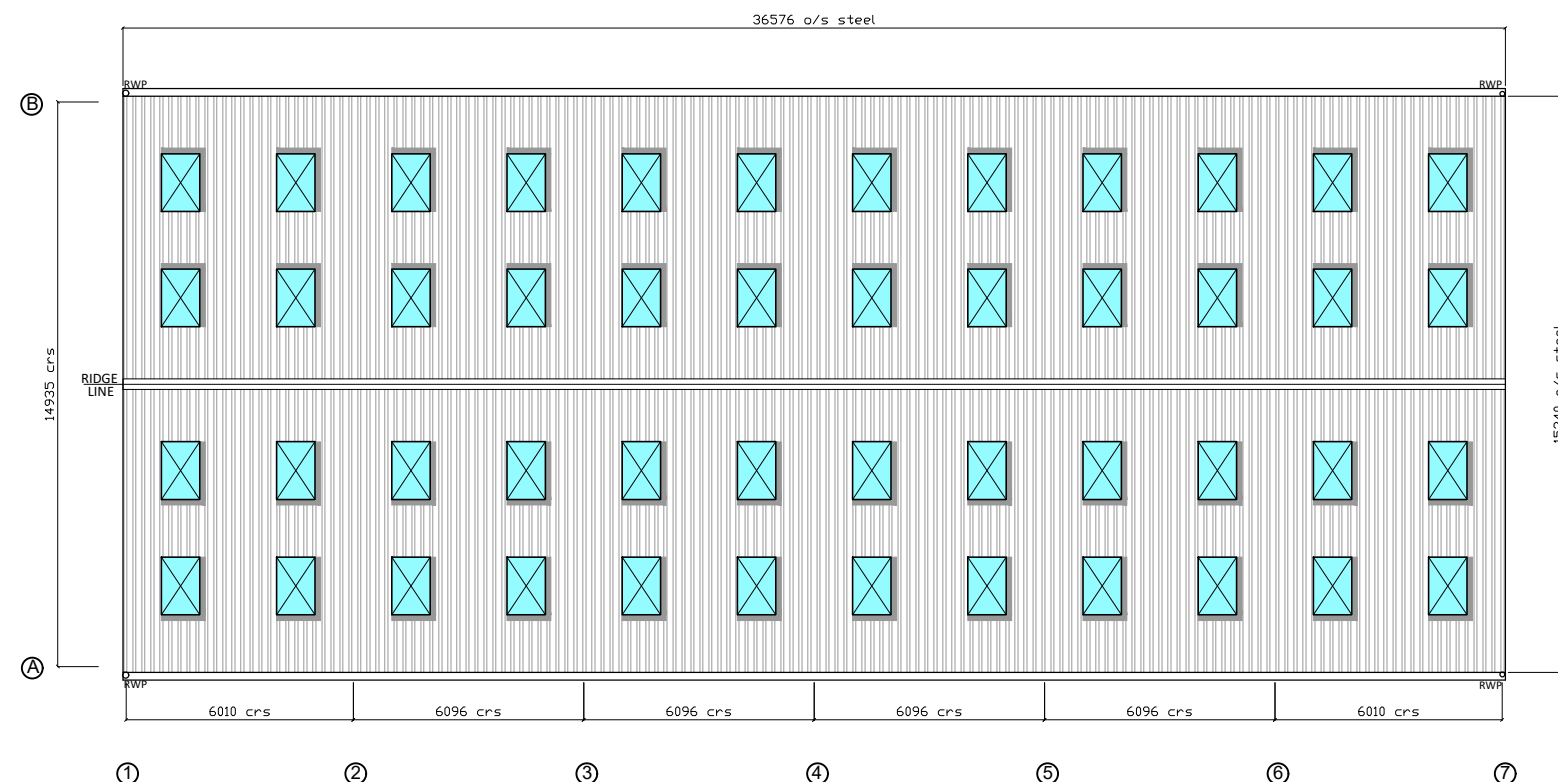

ROOF PLAN

SPECIFICATION:
SIZE: 36.576m (120') LONG x 15.240m (50') WIDE x 5.000m HIGH TO EAVES WITH A 15° ROOF PITCH
STRUCTURE:
 STANCHIONS: 356mm x 171mm x 45kg UB STANCHIONS
 SUB STANCHIONS: 254mm x 146mm x 31kg UB INTERMEDIATE SUB STANCHIONS
 RAFTERS: 305mm x 165mm x 40kg UB RAFTERS WITH RAFTER STAYS
 INCLUDING CHS RAFTER AND SIDE BRACING TO BOTH END BAYS COMPLETE WITH CHS EAVES TIES.
STEELWORK:
 ALL FABRICATED STRUCTURAL STEELWORK DELIVERED TO SITE SHALL INCORPORATE APPROPRIATE "CE" MARKING IN ORDER TO CONFORM TO THE REQUIREMENTS OF BS EN 1090-1.
 ALL STEELWORK TO BE HOT DIPPED GALVANISED.
PURLINS:
 TO SUPPLY GALVANISED STEEL PURLINS BY STEEL SECTION LTD BOLTED TO FRAME AT 1.525M CENTRES. EAVES BEAM TO BE GALVANISED STEEL.
ROOF CLADDING:
 TO SUPPLY 40MM COMPOSITE PANEL ROOF SHEETS COMPRISING OF A 0.5MM PVC TOP SHEET AND 40MM CORE INSULATION WITH A 0.4MM POLYESTER LINING, INCLUDING RIDGE AND VERGE FLASHINGS WITH ALL NECESSARY FIXINGS WITH FOAM FILLERS..
ROOF LIGHTS:
 INCORPORATE 48 NO. 1.525M CORRUGATED 2.40KG/M² GRP CLASS 3 ROOF LIGHTS IN ROOF CLADDING POSITIONED TO SUIT CUSTOMER'S REQUIREMENTS.
RAINWATER GOODS:
 EAVES TO HAVE ROBINSONS STANDARD GALVANISED STEEL BOX GUTTER FIXED EXTERNALLY TO BRACKETS WELDED ONTO STANCHIONS, COMPLETE WITH 2 NO. 110MM Ø PVC DOWNPIPES TO EACH SIDE, INCLUDING MASTIC SEALED JOINTS.
END CLADDING:
 BOTH GABLE ENDS TO BE CLAD DOWN TO 5.000M BELOW EAVES LEVEL WITH 0.7MM THICK COVERWORLD PLASTISOL COATED BOX PROFILE STEEL SHEETS ON 175 X 75 C16 GRADED TANALISED TIMBER SHEETING RAILS WITH FOAM FILLERS.
SIDE CLADDING:
 BOTH SIDES TO BE CLAD DOWN TO 5.000M BELOW EAVES LEVEL WITH 0.7MM THICK COVERWORLD PLASTISOL COATED BOX PROFILE STEEL SHEETS ON 175 X 75 C16 GRADED TANALISED TIMBER SHEETING RAILS WITH FOAM FILLERS.
DOORS:
 1 NO. ROLLER SHUTTER DOOR TO BE 6.000M WIDE X 5.000M HIGH, MANUAL OPERATION, PLAIN GALVANISED STEEL FINISH, POSITIONED CENTRAL ON ONE END.
 1 NO. ROLLER SHUTTER DOOR TO BE 6.096M WIDE X 4.500M HIGH, MANUAL OPERATION, PLAIN GALVANISED STEEL FINISH, POSITIONED ON ONE SIDE.
 1 NO. STRONGDOR 1500 SERIES PERSONNEL DOOR (EXTERNAL LOCKING & EMERGENCY EXIT PUSH BAR).
 2 NO. STRONGDOR 1500 SERIES PERSONNEL DOOR (FIRE EXIT).
CONCRETE PANELS:
 90mm THICK x 0.500m HIGH CONCRETE PANELS TO BOTH ENDS AND BOTH SIDES (EXCLUDING DOORS).

<p>SITE ADDRESS:</p>	<p>CONTACT:</p>	<p>CLIENT:</p>	<p>DRWN BY: A GOWAN CHK'D BY: A ROBB A3 SCALE: 1:200</p>	<p>DATE: 07-10-20 DATE: 07-10-20</p>	<p>REVISIONS:</p> <table border="1"> <thead> <tr> <th>Rev.</th> <th>Date</th> <th>Description</th> <th>By</th> </tr> </thead> <tbody> <tr> <td> </td> <td> </td> <td> </td> <td> </td> </tr> </tbody> </table>	Rev.	Date	Description	By				
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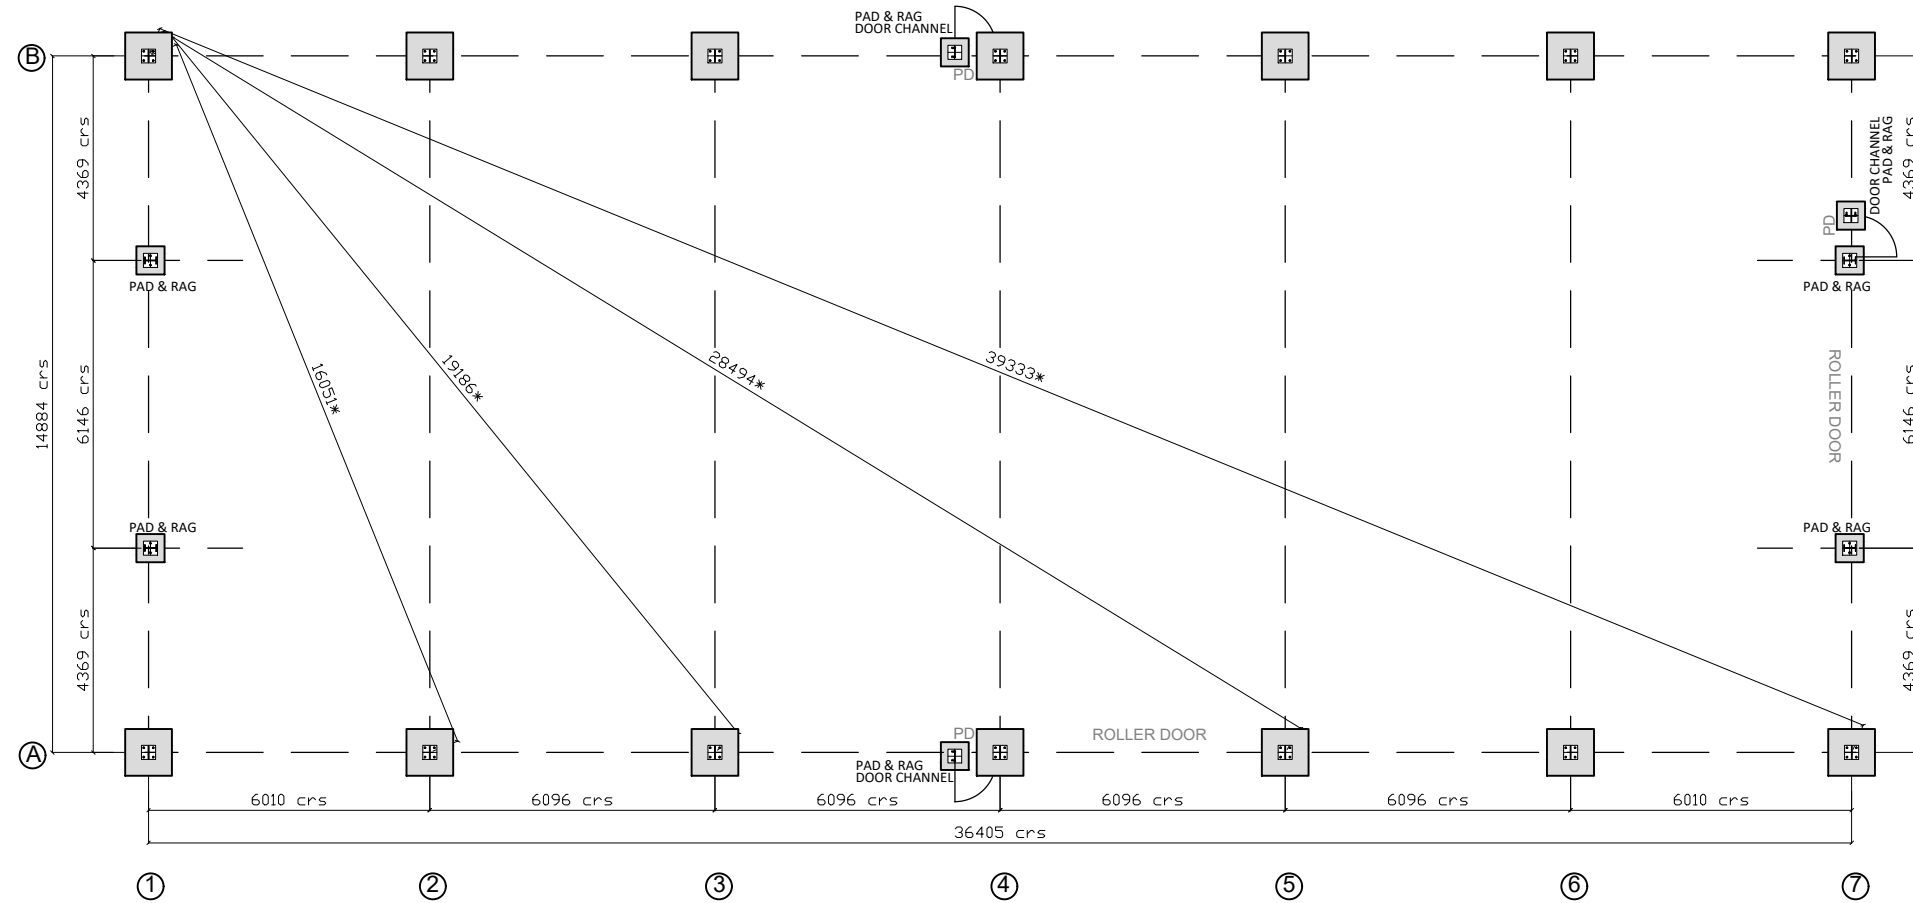
CONTACT:

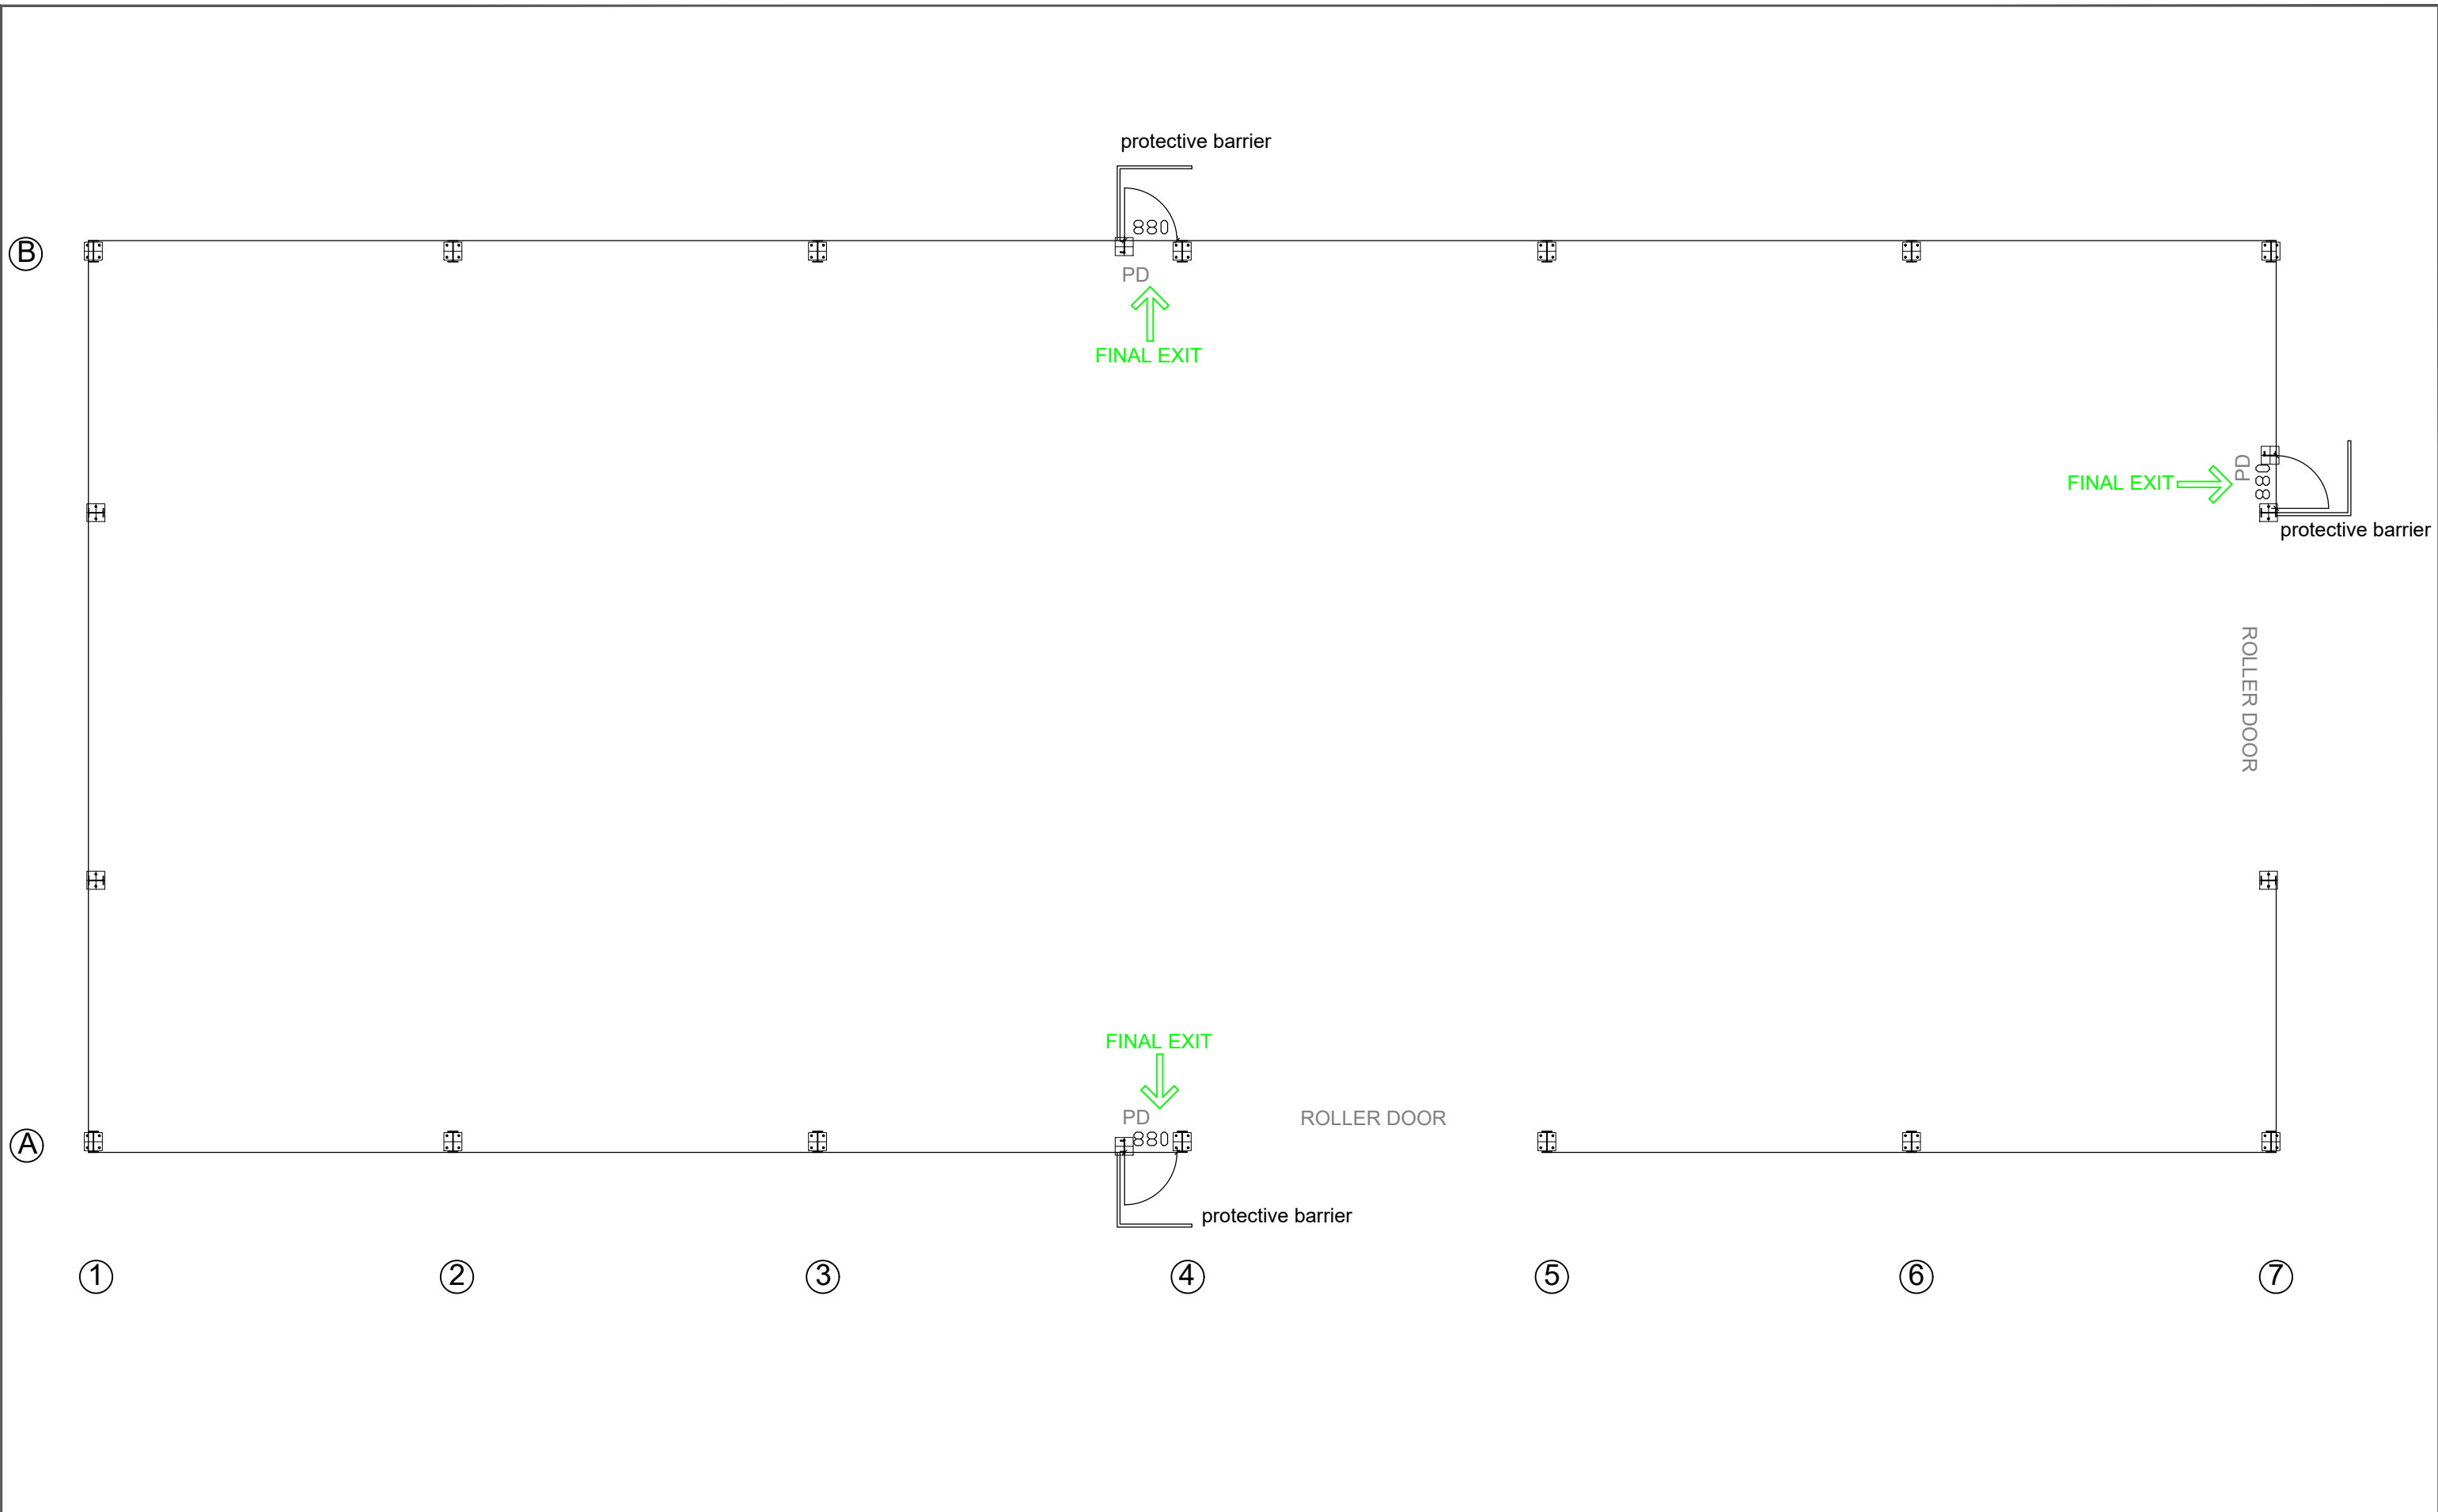TITLE:
FLORR PLAN

CLIENT:


DRWN BY: A GOWAN	DATE: 07-10-20
CHK'D BY: A ROBB	DATE: 07-10-20
A3 SCALE: 1:100	
REVISIONS:	
Rev.	Date
Description	By
DRG. No. RS20-0000-0000-05	
Rev.	

36.576m x 15.240m x 5.000m BUILDING ON 356mm x 171mm x 45kg UB STANCHIONS




AGRICULTURE FOUND DETAILS

4 BOLT DETAIL

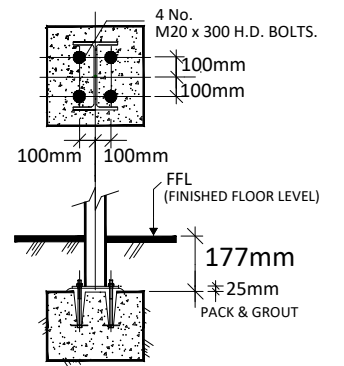

N.B. FFL IS TO BE LEVEL

**HOLDING DOWN BOLT
TIMBER TEMPLATE DETAIL**

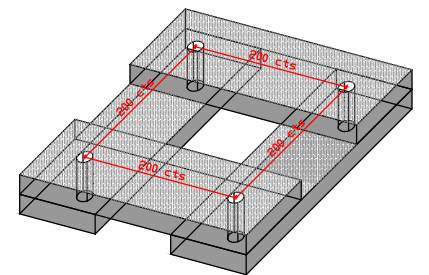

NOTE.

FOUNDATION PAD SIZES ARE NOT STATED/SUPPLIED DUE TO VARYING SITE CONDITIONS. PLEASE CONTACT US IF YOU REQUIRE STRUCTURAL ENGINEER DESIGN/CERTIFICATION FOR THE BUILDING.

ANY BUILDING WHICH IS ATTACHED TO AN EXISTING SHED, EAVES DETAIL AND HEIGHT, BAY CENTRES AND STEEL SIZES MUST BE MEASURED, AS THIS INFORMATION IS REQUIRED FOR THE MANUFACTURE OF YOUR BUILDING.

PLEASE MAKE SURE THE DOOR POSITIONS MEET YOUR REQUIREMENTS

DIMENSIONS MARKED * ARE CHECK DIMENSIONS ONLY

<p>SITE ADDRESS:</p>	<p>CONTACT:</p>	<p>CLIENT:</p>	<p>DRWN BY: A GOWAN</p>	<p>DATE: 07-10-20</p>								
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