| Agenda Item | 7.1 |
|-------------|------------|
| Report No | PLN/030/23 |

HIGHLAND COUNCIL

| Committee: | North Planning Applications Committee |
|---------------|--|
| Date: | 19 April 2023 |
| Report Title: | 22/05454/FUL: Mr Calum Davies, Whyte and Mackay |
| | Land 300M West of Unit 3-7, Cromarty Firth Industrial Park |
| | Invergordon |
| | |

Report By: Area Planning Manager - North

Purpose/Executive Summary

- **Description:** Erection of whisky maturation warehouses, gatehouse, office/welfare and associated infrastructure
- Ward: 06 Cromarty Firth

Development category: Major

Reason referred to Committee: Major development

All relevant matters have been taken into account when appraising this application. It is considered that the proposal accords with the principles and policies contained within the Development Plan and is acceptable in terms of all other applicable material considerations.

Recommendation

Members are asked to agree the recommendation to **GRANT** the application as set out in section 11 of the report

1. PROPOSED DEVELOPMENT

- 1.1 Planning permission is sought for a whisky maturation and storage facility. The development comprises 42 warehouses, with a mix of two and three cell designs. The warehouses will be of a gable roofed design, with a roof ridge height of some 14m, a depth of 32m and a maximum width, for the three-cell design of some 103m. Each will be finished in profiled metal wall and roof cladding, in a grey and grey / green colour, RAL 7009 on the external walls and RAL 7003 on the roof sheeting.
- 1.2 The warehouse development will be demarcated by security fencing with a new security gatehouse as well as a small office / welfare building and firefighting plant in the southern part of the site. The development also includes satellite personnel facilities and forklift sheds in addition to a new drainage system incorporating five new Sustainable Urban Drainage System (SUDS) basins.
- 1.3 The site is currently served with a junction onto the access road to the Cromarty Firth Industrial Park to the east, connecting onto the U4242 distributor road to the south.
- 1.4 Pre-Application Consultation: while no official pre application consultation has taken place with the planning authority, the planning submission has been informed through dialogue with Council officers during the Environmental Impact Assessment Screening process.
- 1.5 The applicant undertook public consultation in the form of a webpage that was open to public comments from 3 23 October 2022. Live consultation events were held via the website, as well an in-person consultation event on 3 October at Invergordon Distillery.
- 1.6 Supporting Information: Arboricultural Method Statement, Design and Access Statement, Drainage Impact Assessment, Environmental Impact Assessment Report (EIAR) and addenda, Landscape Specification, Planning Statement Pre-Application Consultation (PAC) Report, Statement on National Planning Framework (NPF) 4 Outcomes, Transport Statement
- 1.7 Variations:
 - Additional access information 5 January 2023
 - Further Site Investigation information 20 January 2023
 - Amended drainage details 23, 27 January 2023
 - EIAR addendum Non-Methane Volatile Organic Compounds -23 January 2023
 - Tree Protection Plan 27 January 2023
 - Public art proposals 1 January 2023
 - EIAR addendum on ecology and biodiversity 20 February 2023

• Statement on NPF 4 – 24 February 2023

SITE DESCRIPTION

- 2.
- 2.1 The application site extends to some 48 Ha of mainly agricultural land, although some of the eastern portions are part of the Cromarty Firth Industrial Park, formerly the Invergordon Smelter site. The site is approximately square shaped and is bounded to the north by an earthwork bund surrounding a watercourse, known as the 'big ditch', to the east by the Cromarty Firth Industrial Park built on the former Invergordon Aluminium Smelter site, to the west by the Academy Road public road, connecting to the A9 trunk road and to the south by the U4242 Invergordon Saltburn Industrial Estate Distributor Road.
- 2.2 The site is generally of an open aspect, although sections of the original field boundaries and shelter belts remain. An overhead transmission line on timber poles runs through the western portion of the site. A further watercourse, 'Johnstone's Ditch' runs across the centre of the site approximately east to west.
- 2.3 There are no statutory natural heritage designations within the site boundary. The nearest are the Cromarty Firth Special Protection Area (SPA) and Site of Special Scientific Interest (SSSI). The SPA is noted for its use by internationally important breeding populations of osprey and common tern and wintering populations of whooper swan, bar-tailed godwits and greylag geese. The SSSI is noted for its for its intertidal sand and mud flats, saltmarsh habitats and for its nationally important populations of wintering whooper swan, bartailed godwit, wigeon, redshank and red-breasted merganser
- 2.4 Otherwise, there are no national or local landscape designations within the application site boundary. There are no Scheduled Ancient Monuments, Listed Buildings or Conservation Areas within the site

3. PLANNING HISTORY

| 3.1 | 5 October 2022 | 22/03887/SCRE, Whisky maturation warehousing site, offices, associated roads and infrastructure | EIA required |
|-----|----------------------|---|---------------------------|
| 3.2 | 27 September 2022 | 22/03450/PAN, Whisky maturation warehousing site and associated roads and infrastructure. | Presented to Committee |

4. PUBLIC PARTICIPATION

4.1 Advertised:

Ross-shire Journal - Environmental Statement 30 Days Edinburgh Gazette - Environmental Statement 30 Days Ross-shire Journal - Schedule 3 development (14 days) Date Advertised: 16 December 2022 Representation deadline: 15 January 2023

Timeous representations: 1 from 1 household

Late representations: 1 from 1 household

- 4.2 Material considerations raised are summarised as follows:
 - a) Concerns over the principle of the development on greenfield land.
 - b) Concerns regarding atmospheric emissions of Volatile Organic Compounds (VOC's) from the proposed site.
- 4.3 All letters of representation are available for inspection via the Council's eplanning portal which can be accessed through the internet <u>www.wam.highland.gov.uk/wam</u>.

5. CONSULTATIONS

- 5.1 **Invergordon Community Council**: objected to the proposals, raising concerns over the potential for emissions of Volatile Organic Compounds (VOC's) from the proposed facility, having sought technical guidance.
- 5.2 **Access Officer**: does not object to the application. No further comment was required as there are no access demands or opportunities on the application site.
- 5.3 **Contaminated Land Team**: do not object to the application The applicant must provide a scheme to deal with potential contamination, secured by condition.
- 5.4 **Development Plans Team**: provided comments on the status of the proposals with regard to the existing and adopted LDP and in the context of Draft National Planning Framework (NPF) 4. The proposal is primarily warehouses and whilst the immediate land uses are of an industrial nature, the site lies on the northern edge of Invergordon and appropriate screening will be required.
- 5.5 **Environmental Health**: do not object to the application. A construction Noise Mitigation Scheme, Odour Screening Assessment and Air Quality Screening are suggested to be enforced via condition.
- 5.6 **Flood Risk Management Team**: do not object to the application. The Team provided comments for the applicant on the surface water drainage design and recommended conditions securing the final design details as well as in relation to watercourse separation buffers.

- 5.7 **Forestry Officer**: did not object to the application, being satisfied that the arboricultural information submitted demonstrated suitable details to ensure the protection of retained trees during construction. A condition is attached to ensure qualified oversight of the tree works proposed.
- 5.8 **Health and Safety Executive:** had no comments to make on the planning application. Hazardous Substance Consent will be required before any storage of alcohol commences on site.
- 5.9 **Historic Environment Team (Archaeology)**: do not object to the application. They recommended that a programme of work for the survey and recording of any features of archaeological and historic interest in advance of development or site clearance, be secured via condition.
- 5.10 **Transport Planning Team**: do not object to the application, subject to a condition to secure a Construction Traffic Management Plan in advance of development commencing.
- 5.11 **Historic Environment Scotland**: do not object to the application. The proposals are considered unlikely to have any impact on heritage assets within their remit.
- 5.12 **Nature Scot**: did not object to the application. While there are natural heritage interests close to the site, NatureScot advises that these will not be adversely affected by the proposal overall. The Council was advised to carry out an appropriate assessment in terms of the impact of the proposals on Greylag Goose and Whooper Swan.
- 5.13 **Scottish Water**: do not object to the application advising that there is sufficient capacity in the local water supply and public sewer network to service the proposals. Given the scale of the proposals, the development may impact upon existing Scottish Water assets and the applicant should contact the agency to any potential conflict can be identified.
- 5.14 **SEPA** did not object to the application, following the receipt of further details from the applicant on flood risk, drainage design and habitat enhancement and naturalisation of the watercourses as part of the development. SEPA also provide separate comments on the issues regarding Volatile organic Compounds (VOC's) raised by the Invergordon Community Council. Further information was provided on elements of the proposals that would fall under other elements of SEPA's licencing and regulatory regime.
- 5.15 **Transport Scotland**: do not object to the application, subject to a condition being attached to secure a Construction Traffic Management Plan in advance of development commencing.

6. DEVELOPMENT PLAN POLICY

The following policies are relevant to the assessment of the application

National Planning Framework 4 Policies

- 6.1 1. Tackling the climate and nature crises
 - 2. Climate mitigation and adaptation
 - 3. Biodiversity
 - 4. Natural places
 - 5. Soils
 - 9. Brownfield, vacant and derelict land and empty buildings
 - 13. Sustainable transport liveable places
 - 22. Flood risk and water management
 - 23. Health and safety
 - 26. Business and industry

6.2 Highland Wide Local Development Plan 2012

- 28 Sustainable Design
- 29 Design Quality and Place-making
- 30 Physical Constraints
- 31 Developer Contributions
- 34 Settlement Development Areas
- 41 Business and Industrial Land
- 42 Previously Used Land
- 51 Trees and Development
- 55 Peat and Soils
- 56 Travel
- 57 Natural, Built and Cultural Heritage
- 58 Protected Species
- 59 Other Important Species
- 60 Other Important Habitats
- 61 Landscape
- 63 Water Environment
- 64 Flood Risk
- 65 Waste Water Treatment
- 66 Surface Water Drainage
- 70 Waste Management Facilities
- 72 Pollution
- 77 Public Access

6.3 Inner Moray Firth Local Development Plan (IMFLDP) (2015)

The site is located partly within the defined settlement development area (SDA) for Invergordon. Part of the land is allocated (site reference IG8) in the IMFLDP for mixed residential, retail and business uses, with an indicative capacity of 225 homes

6.4 Inner Moray Firth Proposed Local Development Plan (IMFLDP2) (2022)

Site IG8 is not continued in the draft plan.

Policy 7 – Industrial land

6.4 Highland Council Supplementary Planning Policy Guidance

Construction Environmental Management Process for Large Scale Projects (Aug 2010) Developer Contributions (Nov 2018) Flood Risk & Drainage Impact Assessment (Jan 2013) Highland Historic Environment Strategy (Jan 2013) Highland's Statutorily Protected Species (Mar 2013) Managing Waste in New Developments (Mar 2013) Physical Constraints (Mar 2013) Public Art Strategy (Mar 2013) Roads and Transport Guidelines for New Developments (May 2013) Standards for Archaeological Work (Mar 2012) Sustainable Design Guide (Jan 2013) Trees, Woodlands and Development (Jan 2013)

7. OTHER MATERIAL CONSIDERATIONS

7.1 Scottish Government Guidance Designing Streets

Creating Places

8. PLANNING APPRAISAL

8.1 Section 25 of the Town and Country Planning (Scotland) Act 1997 requires planning applications to be determined in accordance with the development plan unless material considerations indicate otherwise.

Determining Issues

8.2 This means that the application requires to be assessed against all policies of the Development Plan relevant to the application, all national and local policy guidance and all other material considerations relevant to the application.

Planning Considerations

- 8.3 The key considerations in this case are:
 - a) compliance with the development plan and other planning policy
 - b) siting, design and amenity
 - c) access and servicing
 - d) flood risk and surface water drainage
 - e) natural heritage
 - f) Impact on infrastructure and services and proposed mitigation (developer contributions)

g) any other material considerations.

Development plan/other planning policy

- 8.4 Both the National Planning Framework 4, Highland wide Local Development Plan (HwLDP) and Inner Moray Firth Local Development Plan (IMFLDP) support the principle of sustainable economic growth and the prospect of new business and industrial developments where these are in sustainable locations. Development proposals that bring previously used land back into a beneficial use are also supported. Development should be directed to allocated sites in the first instance.
- 8.5 All development requires to be assessed against Policy 1 of NPF4 'Tackling the climate and nature crises' which states that when considering development proposals significant weight will be given to global and climate nature crises with the intent of the policy being to encourage, promote and facilitate development that addresses the global climate emergency and nature crisis. The intended policy impacts include promoting local living and compact urban growth. Under NPF 4 Policy 2, development proposals should be sited and designed to minimise lifecycle greenhouse gas emissions as much as possible.
- 8.6 Policy 3 Biodiversity applies to all development proposals. This seeks to protect biodiversity. Reverse biodiversity loss, deliver positive effects from development and strengthen nature networks. For local developments such as this one (albeit on a wider development site) Policy 3c states that proposals for local development will include measures to conserve, restore and enhance biodiversity, in accordance with national and local guidance. Measures should be proportionate to the nature and scale of development.
- 8.7 Policy 4 Natural Places of NPF 4 seeks to protect, restore and enhance the natural assets of designated sites. There are no statutory natural heritage designations within the site boundary. The nearest are the Cromarty Firth Special Protection Area (SPA) and Site of Special Scientific Interest (SSSI). The SPA is noted for its use by internationally important breeding populations of osprey and common tern and wintering populations of whooper swan, bar-tailed godwits and greylag geese. The SSSI is noted for its for its intertidal sand and mud flats, saltmarsh habitats and for its nationally important populations of wintering whooper swan, bartailed godwit, wigeon, redshank and red-breasted merganser. Policy 5 aims to protect carbon rich soils and prime agricultural land, of which portions exist within the application site, as defined through the land capability classification for agriculture developed by Macaulay Land Use Research Institute (now the James Hutton Institute).
- 8.8 Policy 9 Supports development proposals that will result in the sustainable reuse of brownfield land including vacant and derelict land and buildings. In determining whether the reuse is sustainable, the biodiversity value of brownfield land which has naturalised, should be

taken into account.

- 8.9 Policy 13 Sustainable Transport requires development to encourage, promote and facilitate walking, wheeling, cycling and public transport for everyday travel and reduce the need to travel unsustainably. These requirements are also reflected in Policy 56 Travel of the HwLDP.
- 8.10 Consideration has to be given to NPF 4 Policy 22 Flood risk and water management with particular reference to policy 22c) which requires rain and surface water to be dealt with via sustainable urban drainage systems with a presumption against any connections into the combined sewer. 21d) states that development proposals will be supported if they can be connected to the public water mains, this aligns with policies 65 Waste Water Treatment, 66 Surface Water Drainage of the HwLDP.
- 8.11 Policy 23 Health and Safety seeks to protect people and places from environmental harm, mitigate risks arising from safety hazards and encourage, promote and facilitate development that improves health and wellbeing.
- 8.12 Policy 26. Business and Industry of NPF 4 supports development proposals for business and industry uses on sites allocated for those uses in the LDP. tHis Policy is broadly aligned with HwLPD Policy 41 and IMFLPD2 Policy 7
- 8.13 The Inner Moray Firth Local Development Plan is under review and was published as a Proposed Plan in March 2022. It is a material consideration in making planning decisions but not, as yet, part of the approved development plan in terms of the Town and Country Planning (Scotland) Act 1997 (as amended) section 25 overall conformity test. The application site is "de-zoned" from the emerging Plan because there are more sustainably located alternative development sites. The overall reduction in Plan area housing land requirements and the previous lack of active developer interest in the allocation were other factors. Receipt of the Scottish Government Reporters' Report on the new Plan following its Examination is not expected until the end of 2023 at the earliest. This would be when the Plan can be afforded greater weight in decision making.
- 8.14 While the intended direction of the Development Plan is noted, it is considered that it would be challenging to accommodate this scale of development in one of the established business and industrial locations within the plan area. The applicant specifically notes in their EIAR, the benefits of this site, being close to their existing production facilities. While the proposal will directly create relatively few new jobs relative to their scale, they would help safeguard employment in the local area, were the applicant's other distilling and maturation facilities represent a major business concern. There are also environmental benefits in that long distance vehicle movements between the applicant's production facilities and the new maturation complex, would be limited. It is therefore, accepted that the proposals offer the opportunity to support a key local

employer and satisfactorily remediate a significant, partially derelict site. On balance and considering the specific locational needs of the proposal, the loss of the pockets of prime agricultural land within the site is considered acceptable.

Layout, design and visual impact / amenity

- 8.15 The development will comprise 42 warehouses, 5 of a two-cell and 37 of a three-cell design, with a total of 121 cells. As proposed, these will be arranged in three columns and eleven rows of warehouses running southeast to northwest across the site, and a further column extending from southwest to northeast. While the scale of the development is acknowledged, the proposed development, if approved, will be built out in a series of five phases, with an anticipated end date of the whole project, of 2077.
- 8.16 The applicant has submitted a comprehensive scheme of landscaping, including woodland and scrub as well as meadow planting, to be undertaken upfront within the development programme. A programme for the management and maintenance of this planting has also been provided. As such, the planting will provide increased screening of the development as it matures, with the maximum amount of screening achieved towards completion of the final phases. The dark recessive colour scheme proposed will also help somewhat, to integrate the warehouses with the surrounding landscape.
- 8.17 The applicant's Environmental Impact Assessment Report (EIAR) presents a visual impact assessment of the proposals, taken from four nearby viewpoints. Given that the application site borders on existing industrial facilities of a similar scale to both the east and south, the main visual impacts will be felt from the west and north, mainly from receptors travelling east to west on the A9 trunk road as well as users of Academy Road and the Polish War Memorial Core Path RC23.02.
- 8.18 While the scale of the development will be immediately apparent to these receptors, it is considered that for trunk and local road users, views of the proposals will be fleeting and broken up by both the proposed landscaping and planting, as well as the existing belts of retained mature trees that border the site to the northeast and west. The proposals will extend the built area of Invergordon visibly further to the north, but this will be seen against the existing backdrop of industrial development in the north of the Town, as well as elements of the Port of Cromarty Firth, lying to the south. Viewed from the west, for core path users, the proposals will again extend the built-up area of the town closer to the viewer, however, the developed area will again be mostly backdropped by the existing Cromarty Firth Industrial Park and screened by the existing mature tree belts along Academy Road. The applicant's proposed screening planting will also provide further cover as it takes hold. As such, it is considered that development of the scale proposed can be accommodated without unacceptable impact on the surrounding visual amenity.

8.19 In addition to the warehousing, the applicant also proposes a supporting gatehouse and office / staff welfare block in the southeastern corner of the site alongside a switch room and a pump house and tanks for firefighting purposes. There will also be several forklift sheds and satellite toilet locations placed throughout the development. Due to the comparative scale of these elements against that of the warehouses, they raise no further issues in terms of visual amenity.

Access and servicing

- 8.20 The proposals will connect to the Cromarty Firth Industrial Park access road, which itself connects to the U4242 distributor road. The existing access junction will be upgraded with new white lining and guardrails as well as a 2m wide footpath. The applicant has submitted a swept path analysis into the complex for an articulated truck and trailer.
- 8.21 The Transport Statement states that most vehicle movements to the new maturation complex will be from the applicant's existing Whyte & Mackay warehousing site in Academy Road. The proposed return HGV vehicle movements will be an average of 10 daily or 1 per hour. Staff movements are expected to be on average 5 cars daily and cycle parking is also provided on site. 21 car parking spaces will be provided at the new facility which will include 2 disabled bays, 5 EV charging bays and 14 standard spaces. The Transport Planning Team and Transport Scotland were consulted on the proposals and raised no objection to these arrangements.
- 8.22 The ancillary personnel buildings on site will connect to the existing public water supply network and to a private foul sewer that serves the adjacent Cromarty Firth Industrial Park.
- 8.23 The Access Officer has confirmed no objections to the proposal as the proposal will not be accessible to the public and offers no opportunities for enhancing existing access routes.

Flood risk and surface water drainage

8.24 The application site is designated on the SEPA maps as at risk of 1 in 200 and 1 in 1000-year fluvial (river) flood events and there are also areas at medium risk of pluvial (surface water) flooding located throughout, with a concentration in the northwest corner. The proposals incorporate a Sustainable Urban Drainage (SUDS) system of surface water treatment and detention measures with bio swales located along the main internal road routes, connected to five larger SUDS ponds in the centre of the site. The Flood Risk Management team were consulted on the proposals and raised no objections to these arrangements, subject to conditions regarding setback distances from watercourses and finished floor levels.

Natural heritage and protected species

- 8.25 NPF4 Policies 1-3 apply to all development proposals nationwide. When considering all development proposals, significant weight will be given to the global climate and nature crises. Development proposals will be sited and designed to minimise lifecycle greenhouse gas emissions as far as possible. Development proposals will contribute to the enhancement of biodiversity, including where relevant, restoring degraded habitats and building and strengthening nature networks and the connections between them. Proposals should also integrate nature-based solutions, where possible.
- 8.26 The applicant has submitted a detailed landscaping and planting plan for the site. Most of the mature trees along the northern site boundary and western site boundary with Academy Road will be retained. Following the submission of a Tree Protection Plan the Forestry Officer has raised no objection to the proposals, subject to a condition to implement the measures within.
- 8.27 The site is not located within any natural heritage designations or habitats for protected species. The impact on the Cromarty Firth SSSI, SPA and Ramsar sites in the wider area is considered minimal. The applicant has submitted an ecological assessment report in support of the proposals and pre commencement protected species surveys will be secured by condition, given the scale of the development and its significance within the local area.
- 8.28 Pre application surveys found evidence of roosting bats in the southern of the two buildings on the site to be demolished. A condition is attached requiring further surveys to be undertaken in advance of any demolition taking place.

Developer contributions

- 8.29 As this application is for an industrial development, contributions towards affordable housing, education and community facilities are not required in this instance. As a commercial development, the only other contributions potentially required relate to transport, green infrastructure, water/waste and public art. In this instance, the applicant proposes to deliver the necessary waste and water infrastructure and has proposed suitable greenspace and landscaping treatments within the development. The proposed complex can be accessed directly from the public road and no further transport improvements are required to offset the development, as confirmed with the Transport Planning Team and Transport Scotland.
- 8.30 The applicant has indicated parts of the warehouses adjacent the proposed site entrance gatehouse and fronting onto the U4242 distributor road as locations for murals, similar to those installed on their existing maturation warehouses along Academy Road to the south within the town.

Other material considerations:

Climate and nature crises outcomes

8.31 The applicant has submitted an additional statement in respect of NPF 4 Policies 1-3. The proposed warehouses are used for storage only, do not require to be heated and thus, have low energy requirements for their scale. The staff facilities will be electrically heated and cooled, to minimise direct carbon emissions. They incorporate prefabricated panels with a high content of recycled material, minimising waste during the construction phase. The proposed landscaping strategy is also focussed on sustainability and the aim is to improve biodiversity via the introduction of a diverse native planting mix, with a particular focus on pollinator species. Following discussions with SEPA, a Biodiversity Enhancement Plan (BEP) will be secured via condition with respect to enhancing existing habitats and establishing native species on site.

Non-Methane Volatile Organic Compounds (NMVOC's)

- 8.32 The local community council raised concerns over the potential for emissions of Volatile Organic Compounds (VOC's) from the proposed facility. The evaporation of alcohol in spirit maturation facilities is more commonly known as the 'Angels Share'. According to SEPA, in atmospheric pollution chemistry, it is recognised that VOCs can react with polluting nitrogen oxides in air, via photolysis (sunlight), to create tropospheric (ground-level) ozone, or O3. Ozone is implicated in poor air quality, being harmful in high concentrations, and is also a greenhouse gas
- 8.33 The applicant has provided an addendum to their Environmental Impact Assessment Report (EIAR) in this respect. This document states that the closest residential receptor to the proposed development is located approximately 400 m from the proposed development boundary. Over this distance any VOC emissions, point source or fugitive, would be considered to have dispersed significantly in the atmosphere, reducing concentrations to likely to be below recordable levels. On this basis, the need for assessment of VOC emissions was not considered necessary and therefore not included in the EIAR. The response also spoke to the concerns raised by the Community Council over the potential for creation of tropospheric (ground-level) ozone, typically created by the reaction of VOCs with oxides of nitrogen (NOX – typically produced by combustion processes). Through reference to Chapter 9 of the EIAR, it was considered that ambient NOX concentrations are very low, which, when combined with the relatively low sunlight (UV) experienced will inhibit ground level ozone formation. The potential for significant secondary formation of ozone is thus, considered to be minimal.
- 8.34 SEPA have also issued a response to this issue. SEPA does not object to the proposals and is aware of three consequences associated with evaporative losses of ethanol during the storage of distilled spirit in whisky warehousing. These losses are undesirable from the viewpoint of production efficiency and are also a safety concern, particularly if they

build up within the warehousing in concentration. These issues, as they relate to specific warehousing sites, are subject to regulation by SEPA under the Pollution Prevention and Control (Scotland) Regulations 2012 ('PPC'), and the Control of Major Accident Hazards Regulations 2015 ('COMAH').

- 8.35 SEPA also provided comments on the issue of releases of gaseous ethanol from warehouse air to the external atmosphere, which are a focus of the Community Council's concerns. Release rates are very low on a daily basis, and escaped ethanol undergoes fairly steady oxidation in air. External receptors near to whisky warehousing were considered to be at a distance where rapid dilution and dispersion would occur beforehand, meaning initial ethanol concentrations would drop away very quickly. With respect to the wider air environment, gaseous ethanol is regarded as a 'Non Methane Volatile Organic Compound' or NMVOC. SEPA considered that the contribution of NMVOC to air quality would be more significant in urban environments, where more reaction chemistry would take place with other vehicle and industrial air pollutants.
- SEPA's current policy position is based on a 2006 Health Protection 8.36 Board Scotland report, which found no detectable ethanol concentrations beyond the whisky site boundary. At present, SEPA does not regulate the impacts of gaseous emissions from whiskey maturation facilities outside of the site boundary. However, they have confirmed that in the case of this project, considering the representations received, the possible conversion of VOC emissions to tropospheric (ground level) ozone are a material consideration in terms of both the potential for greenhouse gas formation and in so much as they affect local air quality. Inside the site boundary, the Pollution Prevention and Control (Scotland) Regulations 2012 ('PPC'), and The Control of Major Accident Hazards Regulations 2015 ('COMAH') apply. The Scottish Government have commissioned consultants to carry out a study to quantify the emissions of NMVOCs from whisky maturation. Depending on the report's findings and recommendations, SEPA will review the regulatory implications for NMVOC emissions (including gaseous ethanol) under PPC, COMAH and any other relevant regulations.
- 8.37 Within the scope of the Planning System, the issues of NMVOC emissions are weighed against the development plan, especially NPF 4 Policies, 1 and 2, in terms of the impacts on greenhouse gas emissions and climate change and the direct impacts on local health and air quality, through Policy 23. In terms of Policy 23, Environmental Health have recommended conditions to secure an odour impact assessment and screening against the possibility of impacts of the proposed development on local air quality. With respect to Policies 1 and 2, the applicant has concluded in the EIAR addendum that the potential for significant secondary formation of tropospheric (ground level) ozone is considered to be minimal, although no further qualifying information has been submitted to support these findings. However, SEPA consider that the air quality screening document conditioned through consultation with Environmental

Health, provides a suitable tool for helping to address the evaporative loss question. As such, the applicant will be required to provide further quantitative data to allow the potential VOC emissions to be accurately modelled. SEPA would prefer to await the publication of the Whisky Sector NMVOC Report to the Scottish Government, before commenting in any more detail on ethanol releases, and their potential influence. At present, it is not clear as to whether the NMVOC report's terms of reference will terminate at VOC production or include its potential for transformation to tropospheric (ground level) ozone or any subsequent impact on climate change.

Other

- 8.38 A counterpart permission for Hazardous Substances Consent will be required, with further discussion with the Health and Safety Executive (HSE) to assess the principle of storage of alcohol within the development.
- 8.39 It is understood that parts of the application site are subject to a Section 50 agreement as part of the previous planning permission for the Cromarty Firth Industrial Park, RC/1992/52, related to the demolition of elements of the former smelter complex, in addition to landscaping and restoration. There is some evidence that clauses of the original agreement have been addressed. Any further discussions regarding responsibilities for the ongoing maintenance of these areas, or related to a case to discharge the Section 50 agreement, would ultimately, be a legal matter for the owners involved.

Non-material considerations

8.40 The representation comments asked that the applicant should assist with relocation of a local organisations who occupy one of the buildings to be demolished. While these concerns are acknowledged, they are fundamentally, a private matter between the relevant landowners and the organisations concerned, rather than a material consideration within the scope of the planning system.

9. CONCLUSION

- 9.1 The proposal has the potential to help safeguard a major employer's presence in the local area and offer the opportunity to satisfactorily remediate a significant and partially derelict site. However, as with all applications, the benefits of the proposal must be weighed against potential drawbacks and then considered in the round, taking account of the relevant policies of the Development Plan.
- 9.2 It is important to acknowledge the separate and complementary role of both SEPA under the PPC regulations and HSE to cover related issues under the hazardous substances consent process. The Planning Authority recognises and acknowledges the potential significant impacts of the proposals on the environment. No objections have been made in this regard from the relevant

statutory consultees, including Environmental Health, SEPA and Nature Scot. Overall therefore, the Council is satisfied that environmental effects of this development insofar as they relate to planning can be addressed by way of mitigation, as secured through conditions 2 and 3 attached to this permission.

9.3 All relevant matters have been taken into account when appraising this application. It is considered that the proposal accords with the principles and policies contained within the Development Plan and is acceptable in terms of all other applicable material considerations

10. IMPLICATIONS

- 10.1 Resource: Not applicable
- 10.2 Legal: Not applicable
- 10.3 Community (Equality, Poverty and Rural): Not applicable
- 10.4 Climate Change/Carbon Clever: Not applicable
- 10.5 Risk: Not applicable
- 10.6 Gaelic: Not applicable

11. **RECOMMENDATION**

Action required before decision issued

Notification to Scottish Ministers N

Conclusion of Section 75 N Obligation

Revocation of previous N permission

Subject to the above actions, it is recommended to **GRANT** the application subject to the following conditions and reasons

Time limits

1. The development to which this planning permission relates must commence within THREE YEARS of the date of this decision notice. If development has not commenced within this period, then this planning permission shall lapse

Reason: In accordance with Section 58 of the Town and Country Planning (Scotland) Act 1997 (as amended).

Mitigation

There shall be no Commencement of Development unless the Planning Authority has approved in writing the terms of appointment by the Company of an independent Ecological Clerk of Works (ECoW) in consultation with NatureScot and SEPA. The terms of appointment shall;

- a. Impose a duty to monitor compliance with the ecological and hydrological commitments provided in the environmental statement and other information lodged in support of the application, the Construction and Environmental Management Plan, and any other plans approved ("the ECoW works");
- Require the ECoW to report to the Company's nominated construction project manager any incidences of noncompliance with the ECoW works at the earliest practical opportunity;
- c. Require the ECoW to submit a monthly report to the Planning Authority summarising works undertaken on site;
- d. Have power to stop to the job / activities being undertaken within the development site when ecological interests dictate and/or when a breach or potential breach of environmental legislation occurs to allow for a briefing of the concern to the Company's nominated construction project manager; and
- e. Require the ECoW to report to the Planning Authority any incidences of non-compliance with the ECoW Works at the earliest practical opportunity.

The ECoW shall be appointed on the approved terms throughout the period from Commencement of Development, throughout any period of construction activity and during any period of post construction restoration works approved. No later than 3 months after operations cease for 18 consecutive months, the Company shall submit details of the terms of appointment by the Company of an independent ECoW throughout the decommissioning, restoration and aftercare phases of the Development to the Planning Authority for approval in consultation with NatureScot and SEPA. The ECoW shall be appointed on the approved terms throughout the decommissioning, restoration and aftercare phases of the Development.

Reason: To secure effective monitoring of and compliance with the environmental mitigation and management measures associated with the Development.

- 3. No development shall commence until a finalised Construction Environmental Management Document is submitted to and agreed in writing by the Planning Authority in consultation with SEPA and other appropriate consultees as appropriate. The document shall include provision for:
 - i. An updated Schedule of Mitigation (SM);
 - ii. Processes to control / action changes from the agreed Schedule of Mitigation; and
 - iii. The following specific Construction and Environmental Management Plans (CEMPs):
 - I. Details of the construction works, construction methods and surface treatment for all hard surfaces and tracks;
 - Details of watercourse crossings designed to 1 in 200 year flood risk event plus 20% for climate change;
 - III. Details of the temporary site compounds, for the storage of materials and machinery, including the areas designated for offices, welfare facilities; fuel storage and car parking;
 - IV. Details of all soil stripping, excavation, storage and reuse of material. This should also highlight how any contaminated soil will be stored or disposed of (including radioactive contaminants);
 - V. Water Quality Management Plan highlighting drainage provisions including monitoring / maintenance regimes, water crossings, surface water drainage management (SUDs) and development and storage of material buffers (50m minimum) from water features, unless otherwise agreed in writing by SEPA and The Highland Council's Flood Risk Management Team;
 - VI. Public and Private Water Supply Protection Measures Plan;
 - VII. Watercourse Management;
 - VIII. Dust Management;
 - IX. Noise and Vibration Mitigation;
 - X. Pollution Prevention Plan;

- XI. Emergency Response Plan;
- XII. Site Waste Management Plan;
- XIII. Construction Noise Mitigation Plan;
- XIV. Habitat Protection Plan;
- XV. Species Protection Plans: including badger, bat, water vole and otter; and
- XVI. Other relevant environmental management as may be relevant to the development.

The pre construction survey for legally protected species is carried out at an appropriate time of year for the species, at a maximum of 8 months preceding commencement of construction, and that a watching brief is then implemented by the Ecological Clerk of Works (ECOW) during construction. The species that should be surveyed for include, but are not limited to, breeding birds, badger and bats for example. Provision of a communication plan to ensure all contractors are aware of the possible presence of protected species frequenting the site and the laws relating to their protection; The notification and a stop the job commitment requirements set out below: Should a badger set be found during construction, all works within 250m of the set shall stop immediately and the NatureScot Dingwall office be notified and asked for advice. Unless otherwise agreed in writing by the Planning Authority the development shall then proceed in accordance with the approved CEMD.

Reason: To secure the final detailed information on the delivery of all on-site mitigation projects and to protect the environment from the construction and operation of the development.

Landscaping

4. All landscaping works shall be carried out in accordance with the scheme and plans approved as part of this permission. All planting, seeding or turfing as may be comprised in the approved scheme and plans shall be carried out in the first planting and seeding seasons following the commencement of the development, unless otherwise stated in the approved scheme. Any trees or plants which within a period of five years from the completion of the development die, for whatever reason are removed or damaged shall be replaced in the next planting season with others of the same size and species.

Reason: In order to ensure that the approved landscaping works are properly undertaken on site.

Access, drainage and servicing

5. No building within the application site shall come into use unless the vehicular access into the site has been laid out and substantially in accordance constructed with drawing 'EC22808:00:106 REV A' or such other drawings as may subsequently be approved in writing by the planning authority

> Reason: In the interests of road safety and the effective management of the transport network.

6. Prior to commencement of the development, a Construction Traffic Management Plan (CTMP) shall be submitted to, and approved by, the Planning Authority, after consultation with Transport Scotland. The CTMP shall identify the proposed HGV routes to and from the site from the north and south via the A9(T). Thereafter, all construction traffic associated with the development shall conform to the requirements of the agreed Plan.

> Reason: To maintain safety for road traffic and the traffic moving to and from the development, and to ensure that the transportation of abnormal loads will not have any detrimental effect on the road network.

7. No development shall commence until full details of all surface water drainage provision within the application site (which shall accord with the principles of Sustainable Urban Drainage Systems (SUDS) and be designed to the standards outlined in Sewers for Scotland Fourth Edition, or any superseding guidance prevailing at the time) have been submitted to, and approved in writing by, the Planning Authority.

> **Reason**: To ensure that surface water drainage is provided timeously and complies with the principles of SUDS; in order to protect the water environment

8. Notwithstanding the provisions of Article 3 and Schedule 1 of Country Planning the Town and (General Permitted Development) (Scotland) Order 1992 (as amended, revoked or re-enacted; with or without modification), no development shall take place within 6 metres of any watercourse, or within the area shaded blue in Figure 3-4 of the approved Flood Risk Assessment Report dated September 2022.

> **Reason:** To ensure that development does not encroach onto riparian buffer strips. Such buffers strips are required a) for the maintenance of watercourses within the application site, b) to account for natural watercourse migration, and c) in order to safeguard property from flood risk.

9. The minimum Finished Floor Levels (FFL) should be at or above the 1 in 200 year plus climate change flood level plus 600mm freeboard, 7.31mAOD.

> Reason: To ensure that the development is free from flood risk and does not exacerbate flood risk elsewhere.

Construction phase

- 10 Prior to construction commencing the applicant shall submit, for the written approval of the planning authority, a construction noise mitigation scheme which demonstrates how the applicant/contractor will ensure the best practicable measures are implemented in order to reduce the impact of construction noise. The assessment should include but is not limited to the following: -
 - A description of the most significant noise sources in of equipment; processes terms or phases of construction.
 - The proposed operating hours and the estimated duration of the works for each phase.
 - A detailed plan showing the location of noise sources, noise sensitive premises and any survey measurement locations if required).
 - A description of noise mitigation methods that will be put • in place including the proposals for community liaison. The best practice found in BS5228 Code of practice for noise and vibration control on construction and open sites should be followed. Any divergence requires to be iustified.

Thereafter the development shall progress in accordance with the approved Noise Mitigation Scheme and all approved mitigation measures shall be in place prior to construction commencing or as otherwise may be agreed in writing by the Planning Authority.

Reason: In order to safeguard the amenity of neighbouring properties and occupants

- Vibration arising from construction works associated with this development shall not exceed the following limits as measured or calculated at any noise sensitive in accordance with BS 5228-2:2009+A1:2014 Code of practice for noise and vibration control on construction and open sites - Part2: Vibration
 - Monday to Friday 8am to 6pm. The peak particle velocity

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shall not exceed 5 mm·s-1

- Saturdays 8am to 1pm. The peak particle velocity shall not exceed 5 mm·s-1
- Out-with the above times, the peak particle velocity shall not exceed 0.3 mm s-1

The above limits apply to all construction activities other than blasting. For blasting, it is expected that the best practicable measures will be employed to minimise the impact of noise and vibration.

Reason: In order to safeguard the amenity of neighbouring properties and occupants.

12 Prior to the development commencing, the applicant shall submit, for the written approval of the planning authority, details of a dust mitigation scheme designed to protect neighbouring properties from dust arising from this development.

> Thereafter the development shall progress in accordance with the approved dust suppression scheme and all approved mitigation measures shall be in place prior to the commencement of operations or as otherwise may be agreed in writing by the Planning Authority

> **Reason:** In order to safeguard the amenity of neighbouring properties and occupants.

Amenity

13 Prior to the development commencing the applicant shall submit, for the written approval of the planning authority, an Odour Impact Assessment carried out by a suitably qualified and competent person in accordance with the Institute of Air Quality Management's document Guidance on the Assessment of Odour for Planning.

> The assessment should evaluate the likely impact of odour emanating from the development on neighbouring property and should include but is not limited to the following: -

- A description of existing baseline odour conditions (including complaints history) where relevant.
- A description of receptors and their relative sensitivities to odour effects.
- Details of potential odour sources (whether existing or proposed), including the activities and materials involved

- A plan showing the location of sources and receptors.
- The residual odour impacts and their effects and a conclusion on the significance of the residual effect
- A description of any odour mitigation measures which are required in order to allow the proposal to proceed without causing significant loss of amenity.
- Where odour modelling has been used the reports should contain full details of the input data and modelling options used to allow a third party to reproduce the results.
- An Odour Management Plan OMP which formalises and describes how odour issues will be managed on site. As well as covering normal operations, it should anticipate and plan for abnormal events and foreseeable accidents and incidents.

Thereafter the development shall progress in accordance with the approved Odour Impact Assessment and Odour Management Plan. All approved mitigation measures shall be in place prior to the operational phase commencing or as otherwise may be agreed in writing by the Planning Authority.

Reason: In order to safeguard the amenity of neighbouring properties and occupants.

14 Prior to the development commencing the applicant shall submit, for the written approval of the planning authority, in consultation with the environmental health authority and SEPA, a screening document against the possibility of impacts on air quality relevant to the Local Air Quality Management provisions of the Environment Act 1995. Technical guidance on screening is available in Technical Guidance note LAQM.TG16. For the avoidance of doubt, the screening document shall include a site-specific estimate of product loss rate from stock-take data, expressed as a long-term annual average.

Reason: In order to safeguard the amenity of neighbouring properties and occupants.

Contaminated Land

- 15 No development shall commence until a scheme to deal with potential contamination on site has been submitted to and agreed in writing by the Planning Authority. The scheme shall include:
 - i. the nature, extent and type of contamination on site and

identification of pollutant linkages and assessment of risk (i.e. a land contamination investigation and risk assessment), the scope and method of which shall be submitted to and agreed in writing by with the Planning Authority, and undertaken in accordance with PAN 33 (2000) and British Standard BS 10175:2011+A2:2017 Investigation of Potentially Contaminated Sites - Code of Practice;

- ii. the measures required to treat/remove contamination (remedial strategy) including a method statement, programme of works, and proposed verification plan to ensure that the site is fit for the uses proposed;
- iii. measures to deal with contamination during construction works;
- iv. in the event that remedial action be required, a validation report that will validate and verify the completion of the agreed decontamination measures;
- v. in the event that monitoring is required, monitoring statements shall be submitted at agreed intervals for such time period as is considered appropriate by the Planning Authority.

Thereafter, no development shall commence until written confirmation has been received that the scheme has been implemented, completed and, if required, monitoring measurements are in place, all to the satisfaction of the Planning Authority.

Reason: In order to ensure that the site is suitable for redevelopment given the nature of previous uses/processes on the site.

Protected species, habitat and ecology

16 No development shall commence until a protected species precommencement survey has been undertaken and a report of survey has been submitted to, and approved in writing by, the Planning Authority. The survey shall cover both the application site and an area of 20 metres in all directions from the boundary of application site and the report of survey shall include mitigation measures where any impact, or potential impact, on protected species or their habitat has been identified. Development and work shall progress in accordance with any mitigation measures contained within the approved report of survey and the timescales contain therein **Reason:** To ensure that the site and its environs are surveyed and the development does not have an adverse impact on protected species or habitat.

17 No demolition works shall commence until the existing buildings . within the application site have been surveyed internally for roosting bats, as specified in the Highland Ecology and Development Bat Activity Survey Reports, dated September 2022, and a Bat Species Protection Plan (SPP) has been submitted to, and approved in writing by, the Planning Authority. The approved SPP shall be implemented in full unless otherwise agreed in writing.

> **Reason:** To ensure that the site and its environs are surveyed and the development does not have an adverse impact on protected species or habitat.

development shall commence until a Biodiversitv No Enhancement Plan (BEP) has been produced and approved in writing by the Planning Authority, in consultation with SEPA and NatureScot. The BEP will detail all biodiversity enhancements to be incorporated into the Proposed Development. The plan will include details on the capital works required to provide enhancements, along with the shortand long-term management prescriptions for each habitat feature, along with a programme of monitoring and review. The stream and ditch on site will be enhanced through provision of a wide margin between the water course and development of a minimum 10m in width. This will be seeded with an appropriate species mix and allowed to establish; this area will be maintained as part of the wildlife corridor and will be allowed to establish into a long sward grassland. Locally native marginal aquatic plants will also be plug planted along the stream, particularly in the western section, in order to improve structure and species diversity of the margins. Areas along the watercourses will be de-shaded, as required.

Reason: To ensure that the development does not have an adverse impact on protected species or habitat.

Landscaping and forestry

19 A suitably qualified arboricultural consultant must be employed at the applicant's expense to ensure that the approved Tree Protection Plan and Arboricultural Method Statement are implemented to the required standard. Stages requiring supervision are to be agreed with the planning authority and certificates of compliance for each stage are to be submitted for approval. No development shall commence until an arboricultural consultant has been appointed and a work instruction issued enabling them to undertake the necessary

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supervision unhindered for the duration of the project.

Reason: In order to ensure the protection of retained trees, which are important amenity assets, both during construction and thereafter.

Archaeology

No development or work (including site clearance) shall commence until a programme of work for the evaluation, preservation and recording of any archaeological and historic features affected by the proposed development/work, including a timetable for investigation, has been submitted to, and approved in writing by, the Planning Authority. The approved programme shall be implemented in accordance with the agreed timetable for investigation.

> Reason: In order to protect the archaeological and historic interest of the site.

REASON FOR DECISION

All relevant matters have been taken into account when appraising this application. It is considered that the proposal accords with the principles and policies contained within the Development Plan and is acceptable in terms of all other applicable material considerations

REASONED CONCLUSION

The Council is in agreement with the findings of the Environmental Impact Assessment Report that the proposed whisky maturation facility is unlikely to give rise to any new or other significant adverse impact on the environment. The Council is satisfied that all environmental effects of this development can be addressed by way of mitigation. The Council has incorporated the requirement for a schedule of mitigation within the conditions of this permission. Monitoring of operational compliance has been secured through Conditions Insert condition number that secure environmental mitigation and monitoring of this permission.

TIME LIMIT FOR THE IMPLEMENTATION OF THIS PLANNING PERMISSION

In accordance with Section 58 of the Town and Country Planning (Scotland) Act 1997 (as amended), the development to which this planning permission relates must commence within THREE YEARS of the date of this decision notice. If development has not commenced within this period, then this planning permission shall lapse.

INFORMATIVES

Initiation and Completion Notices

The Town and Country Planning (Scotland) Act 1997 (as amended) requires all developers to submit notices to the Planning Authority prior to, and upon completion of, development. These are in addition to any other similar requirements (such as Building Warrant completion notices) and failure to comply represents a breach of planning control and may result in formal enforcement action.

- 1. The developer must submit a Notice of Initiation of Development in accordance with Section 27A of the Act to the Planning Authority prior to work commencing on site.
- 2. On completion of the development, the developer must submit a Notice of Completion in accordance with Section 27B of the Act to the Planning Authority.

Copies of the notices referred to are attached to this decision notice for your convenience.

Flood Risk

It is important to note that the granting of planning permission does not imply there is an unconditional absence of flood risk relating to (or emanating from) the application site. The granting of planning permission does not remove the liability position of developers or owners in relation to flood risk.

Scottish Water

You are advised that a supply and connection to Scottish Water infrastructure is dependent on sufficient spare capacity at the time of the application for connection to Scottish Water. The granting of planning permission does not guarantee a connection. Any enquiries with regards to sewerage connection and/or water supply should be directed to Scottish Water on 0845 601 8855.

Local Roads Authority Consent

In addition to planning permission, you may require one or more separate consents (such as road construction consent, dropped kerb consent, a road openings permit, occupation of the road permit etc.) from the Area Roads Team prior to work commencing. These consents may require additional work and/or introduce additional specifications and you are therefore advised to contact your local Area Roads office for further guidance at the earliest opportunity.

Failure to comply with access, parking and drainage infrastructure requirements may endanger road users, affect the safety and free-flow of traffic and is likely to result in enforcement action being taken against you under both the Town and Country Planning (Scotland) Act 1997 and the Roads (Scotland) Act 1984.

Further information on the Council's roads standards can be found at:

http://www.highland.gov.uk/yourenvironment/roadsandtransport

Application forms and guidance notes for access-related consents can be downloaded from:

http://www.highland.gov.uk/info/20005/roads_and_pavements/101 /permits_for_working_on_public_roads/2

Mud & Debris on Road

Please note that it an offence under Section 95 of the Roads (Scotland) Act 1984 to allow mud or any other material to be deposited, and thereafter remain, on a public road from any vehicle or development site. You must, therefore, put in place a strategy for dealing with any material deposited on the public road network and maintain this until development is complete.

Construction Hours and Noise-Generating Activities: You are advised that construction work associated with the approved development (incl. the loading/unloading of delivery vehicles, plant or other machinery), for which noise is audible at the boundary of the application site, should not normally take place outwith the hours of 08:00 and 19:00 Monday to Friday, 08:00 and 13:00 on Saturdays or at any time on a Sunday or Bank Holiday in Scotland, as prescribed in Schedule 1 of the Banking and Financial Dealings Act 1971 (as amended).

Work falling outwith these hours which gives rise to amenity concerns, or noise at any time which exceeds acceptable levels, may result in the service of a notice under Section 60 of the Control of Pollution Act 1974 (as amended). Breaching a Section 60 notice constitutes an offence and is likely to result in court action.

If you wish formal consent to work at specific times or on specific days, you may apply to the Council's Environmental Health Officer under Section 61 of the 1974 Act. Any such application should be submitted after you have obtained your Building Warrant, if required, and will be considered on its merits. Any decision taken will reflect the nature of the development, the site's location and the proximity of noise sensitive premises. Please contact env.health@highland.gov.uk for more information.

Protected Species – Halting of Work

You are advised that work on site must stop immediately, and NatureScot must be contacted, if evidence of any protected species or nesting/breeding sites, not previously detected during the course of the application and provided for in this permission, are found on site. For the avoidance of doubt, it is an offence to deliberately or recklessly kill, injure or disturb protected species or to damage or destroy the breeding site of a protected species. These sites are protected even if the animal is not there at the time of discovery. Further information regarding protected species and developer responsibilities is available from NatureScot: <u>https://www.nature.scot/professional-advice/protected-areas-and-species/protected-species</u>

Designation:Area Planning Manager NorthAuthor:Michael KordasBackground Papers:Documents referred to in report and in case file.

Relevant Plans:

| Document Type | Document No. | Version No. | Date Received |
|--|--|--|---|
| | | | |
| Location Plan Proposed Site Layout Plan Proposed Site Layout Plan Visibility Splay Plan Visibility Splay Plan SUDS Layout Proposed Drainage Layout Storage Tank Layout Varehouse Layout Roof Plans Tree Protection Plan Tree Protection Plan Varehouse Elevations Gatehouse Elevations Welfare Office Elevations Pumphouse Elevations | EC22808:00:101 EC22808:00:102 EC22808:00:103 EC22808:00:106 EC22808:00:121 EC22808:00:105 EC22808:00:104 EC22808:00:104 EC22808:00:107 EC22808:00:109 1333-TPP 1333.2-TPP 1333.3-TPP 1333.3-TPP 1333.5-TPP 1333.5-TPP 1333.6-TPP EC22808:00:108 EC22808:00:117 EC22808:00:118 EC22808:00:112 | REV B REV A REV A REV B REV A REV A REV A REV A | 16 November 2022 27 January 2023 27 January 2023 5 January 2023 5 January 2023 23 January 2023 27 January 2023 16 November 2022 16 November 2022 27 January 2023 27 January 2023 26 November 2022 16 November 2022 16 November 2022 |
| Switchroom Elevations Construction Details Construction Details Sections and Earthworks Sections and Earthworks Public Art Proposals Landscape Plan | EC22808:00:116 EC22808:00:119 EC22808:00:120 EC22808:00:110 EC22808:00:111 102 101 | REV 01 | 16 November 2022 16 November 2022 16 November 2022 16 November 2022 16 November 2022 1 February 2023 16 November 2022 |
| Forklift Shed Elevations | EC22808:00:115 | REV A | 16 November 2022 |



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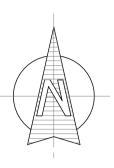
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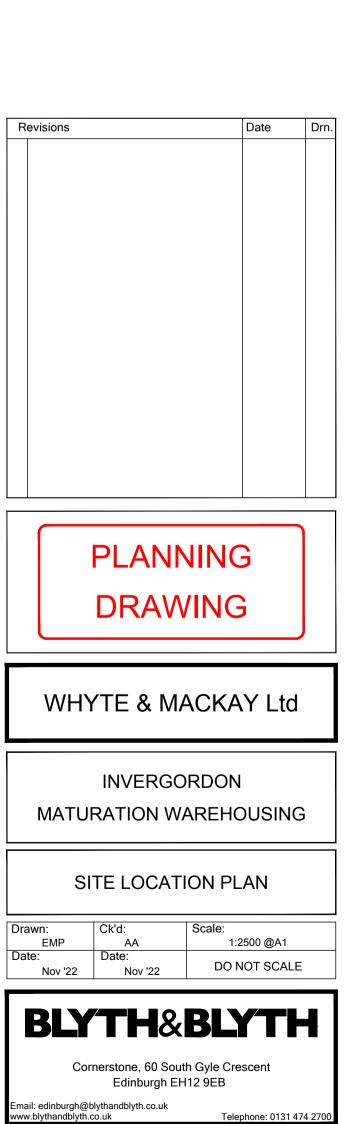
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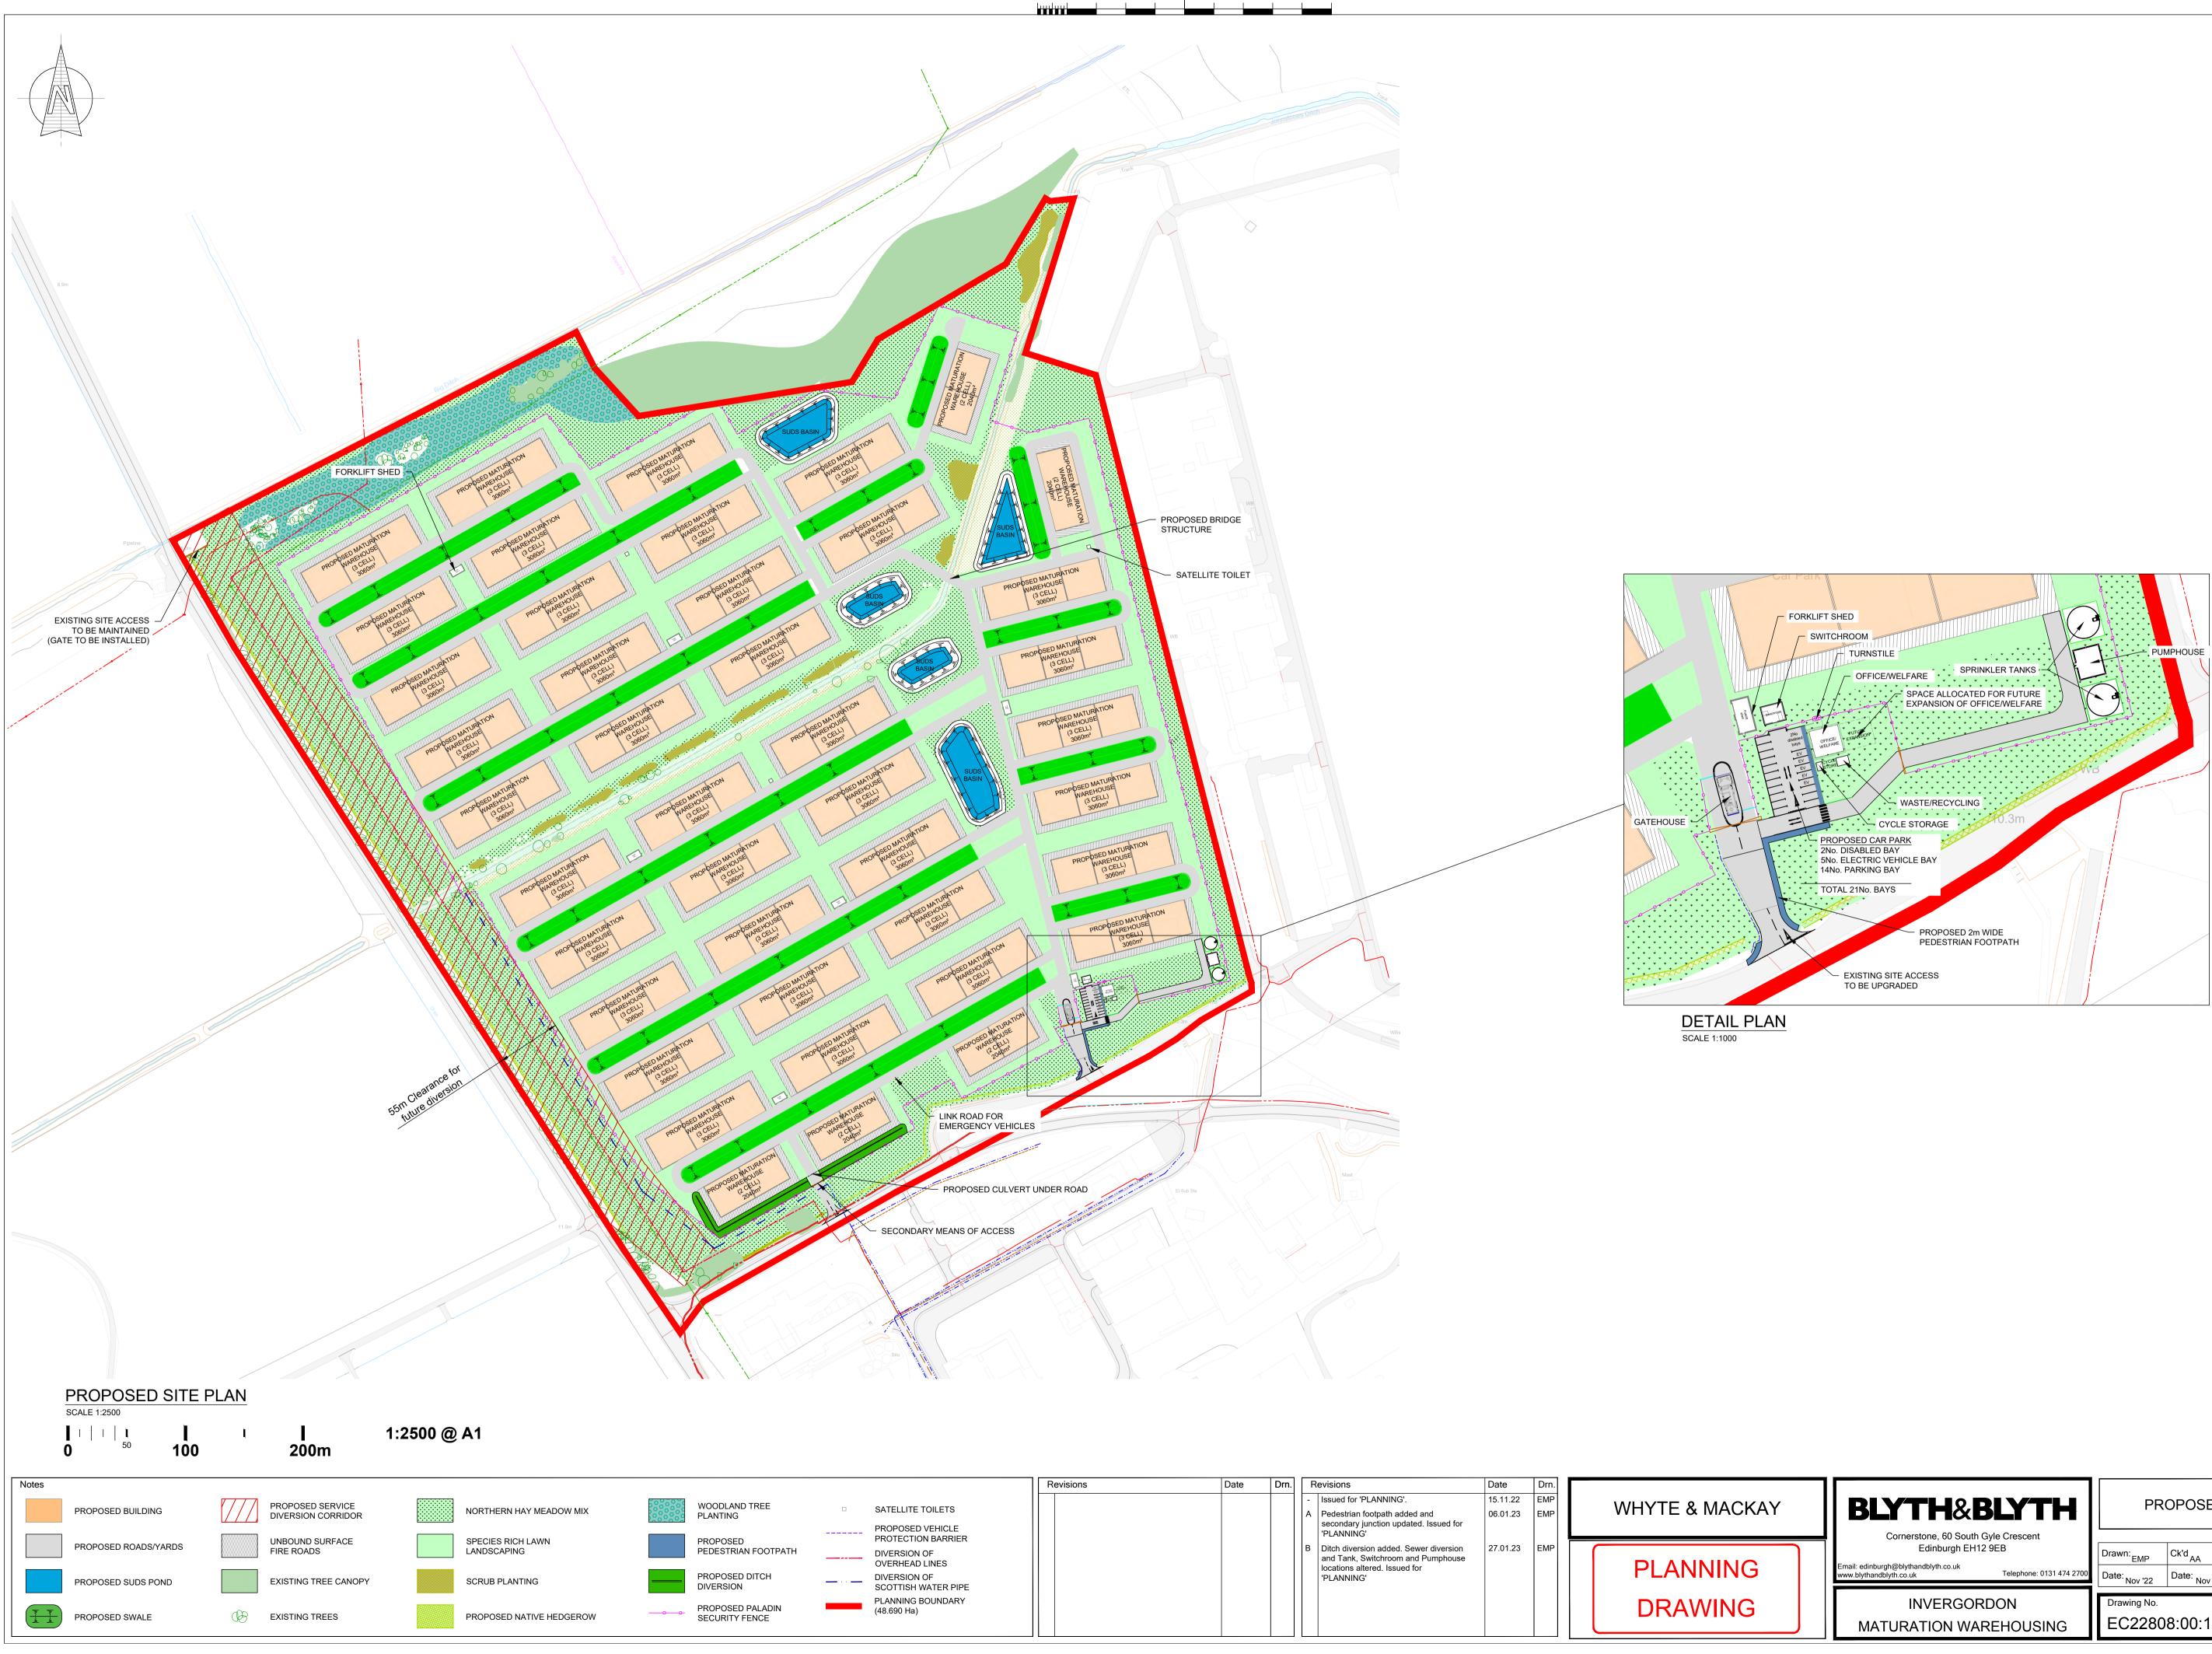
LEGEND

PLANNING BOUNDARY (48.690 Ha)

OWNERSHIP BOUNDARY







| | Revisions | Date | Drn. | R | Revisions | Date | Drn. | |
|---|-----------|------|------|--------|---|----------------------|------------|----------------|
| ATELLITE TOILETS ROPOSED VEHICLE ROTECTION BARRIER | | | | - A | Issued for 'PLANNING'. Pedestrian footpath added and secondary junction updated. Issued for 'PLANNING' | 15.11.22 06.01.23 | EMP EMP | WHYTE & MACKAY |
| IVERSION OF VERHEAD LINES IVERSION OF COTTISH WATER PIPE | | | | В | Ditch diversion added. Sewer diversion and Tank, Switchroom and Pumphouse locations altered. Issued for 'PLANNING' | 27.01.23 | EMP | PLANNING |
| LANNING BOUNDARY 8.690 Ha) | | | | | | | | DRAWING |

PROPOSED SITE PLAN

Scale AS SHOWN @ A1 Date: Nov '22 Date: Nov '22 DO NOT SCALE Revision EC22808:00:102 В



| Revisions | Date | Drn. | R | evisions | Date | Drn. | |
|-----------|------|------|---|---|----------|------|------------------|
| | | | - | Issued for 'PLANNING'. | 15.11.22 | EMP | |
| | | | A | Warehouse labels updated. Issued for 'PLANNING' | 16.11.22 | EMP | WHYTE AND MACKAY |
| | | | В | Ditch diversion added. Sewer diversion | 27.01.23 | EMP | |
| | | | | and Tank, Switchroom and Pumphouse locations altered. Issued for 'PLANNING' | | | PLANNING |
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| | | | | | | | DRAWING |
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Cromarty Firth Industrial Park


BLYTH&BLYTH

Cornerstone, 60 South Gyle Crescent Edinburgh EH12 9EB Email: edinburgh@blythandblyth.co.uk www.blythandblyth.co.uk

Telephone: 0131 474 2700

INVERGORDON MATURATION WAREHOUSING PROPOSED SITE LEVELS

| Drawn: EMP | Ck'd _{AA} | Scale 1:2000 @ A1 |
|---------------|------------------------------|-------------------|
| Date: Nov '22 | Date [.] Nov '22 | DO NOT SCALE |
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SITE ACCESS LOCATION PLAN SCALE 1:1000

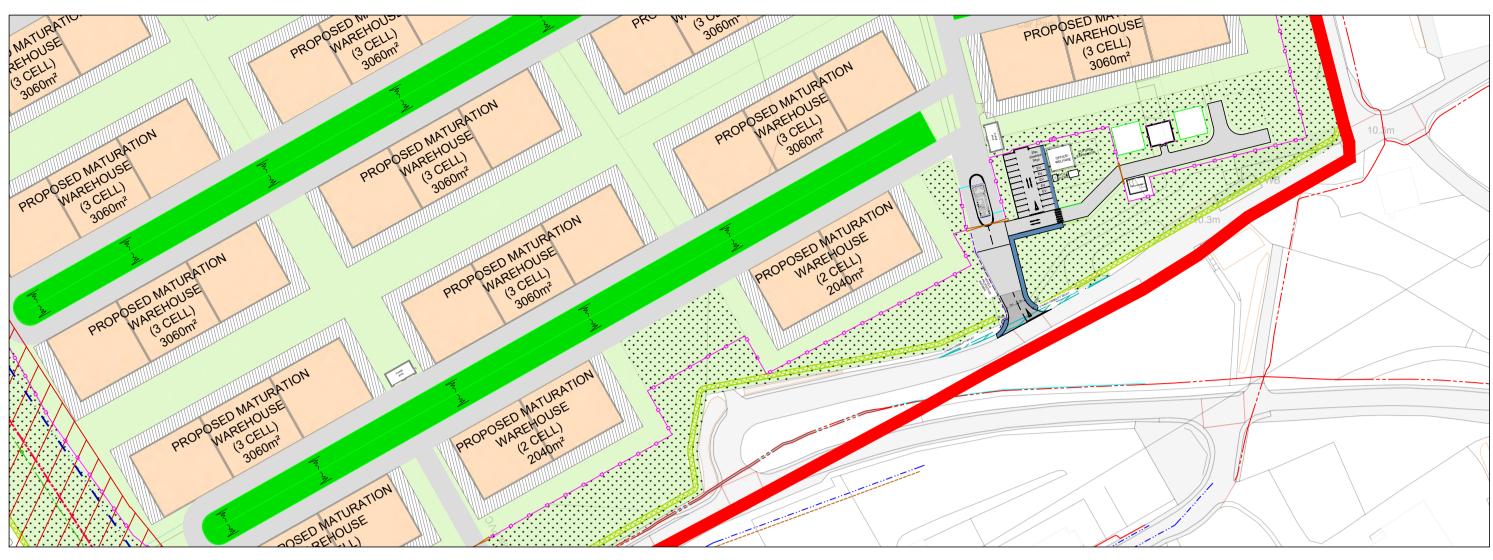
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| VISIBILITY SPLAY PLAN Note: SCALE 1:200 • Visibility splay is 2.4m x 40m for a 30mph road. • Junction to be resurfaced | | | |
| IIII I | | | |
| Notes | Revisions Date Drn. Revision | ons Date Drn. | |
| PROPOSED ROADS/YARDS PROPOSED PEDESTRIAN FOOTPATH | | ed for 'PLANNING'. 15.11.22 EMP estrian footpath added. Issued for 06.01.23 EMP NNING' | HYTE & MACKAY |
| PLANNING BOUNDARY (48.690 Ha) | | | |
| PROPOSED PALADIN SECURITY FENCE | | | PLANNING |
| PROPOSED VEHICLE PROTECTION BARRIER | | | DRAWING |
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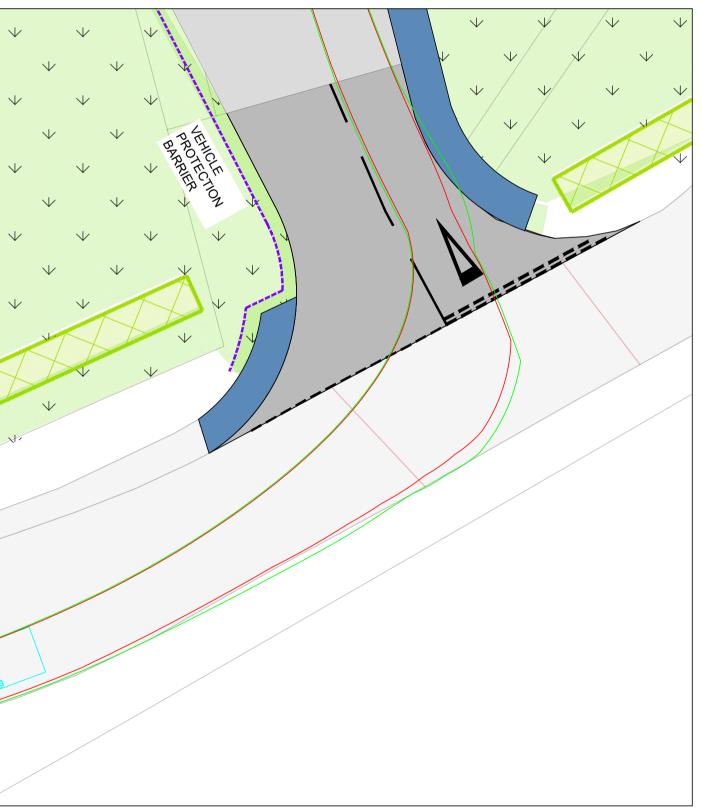
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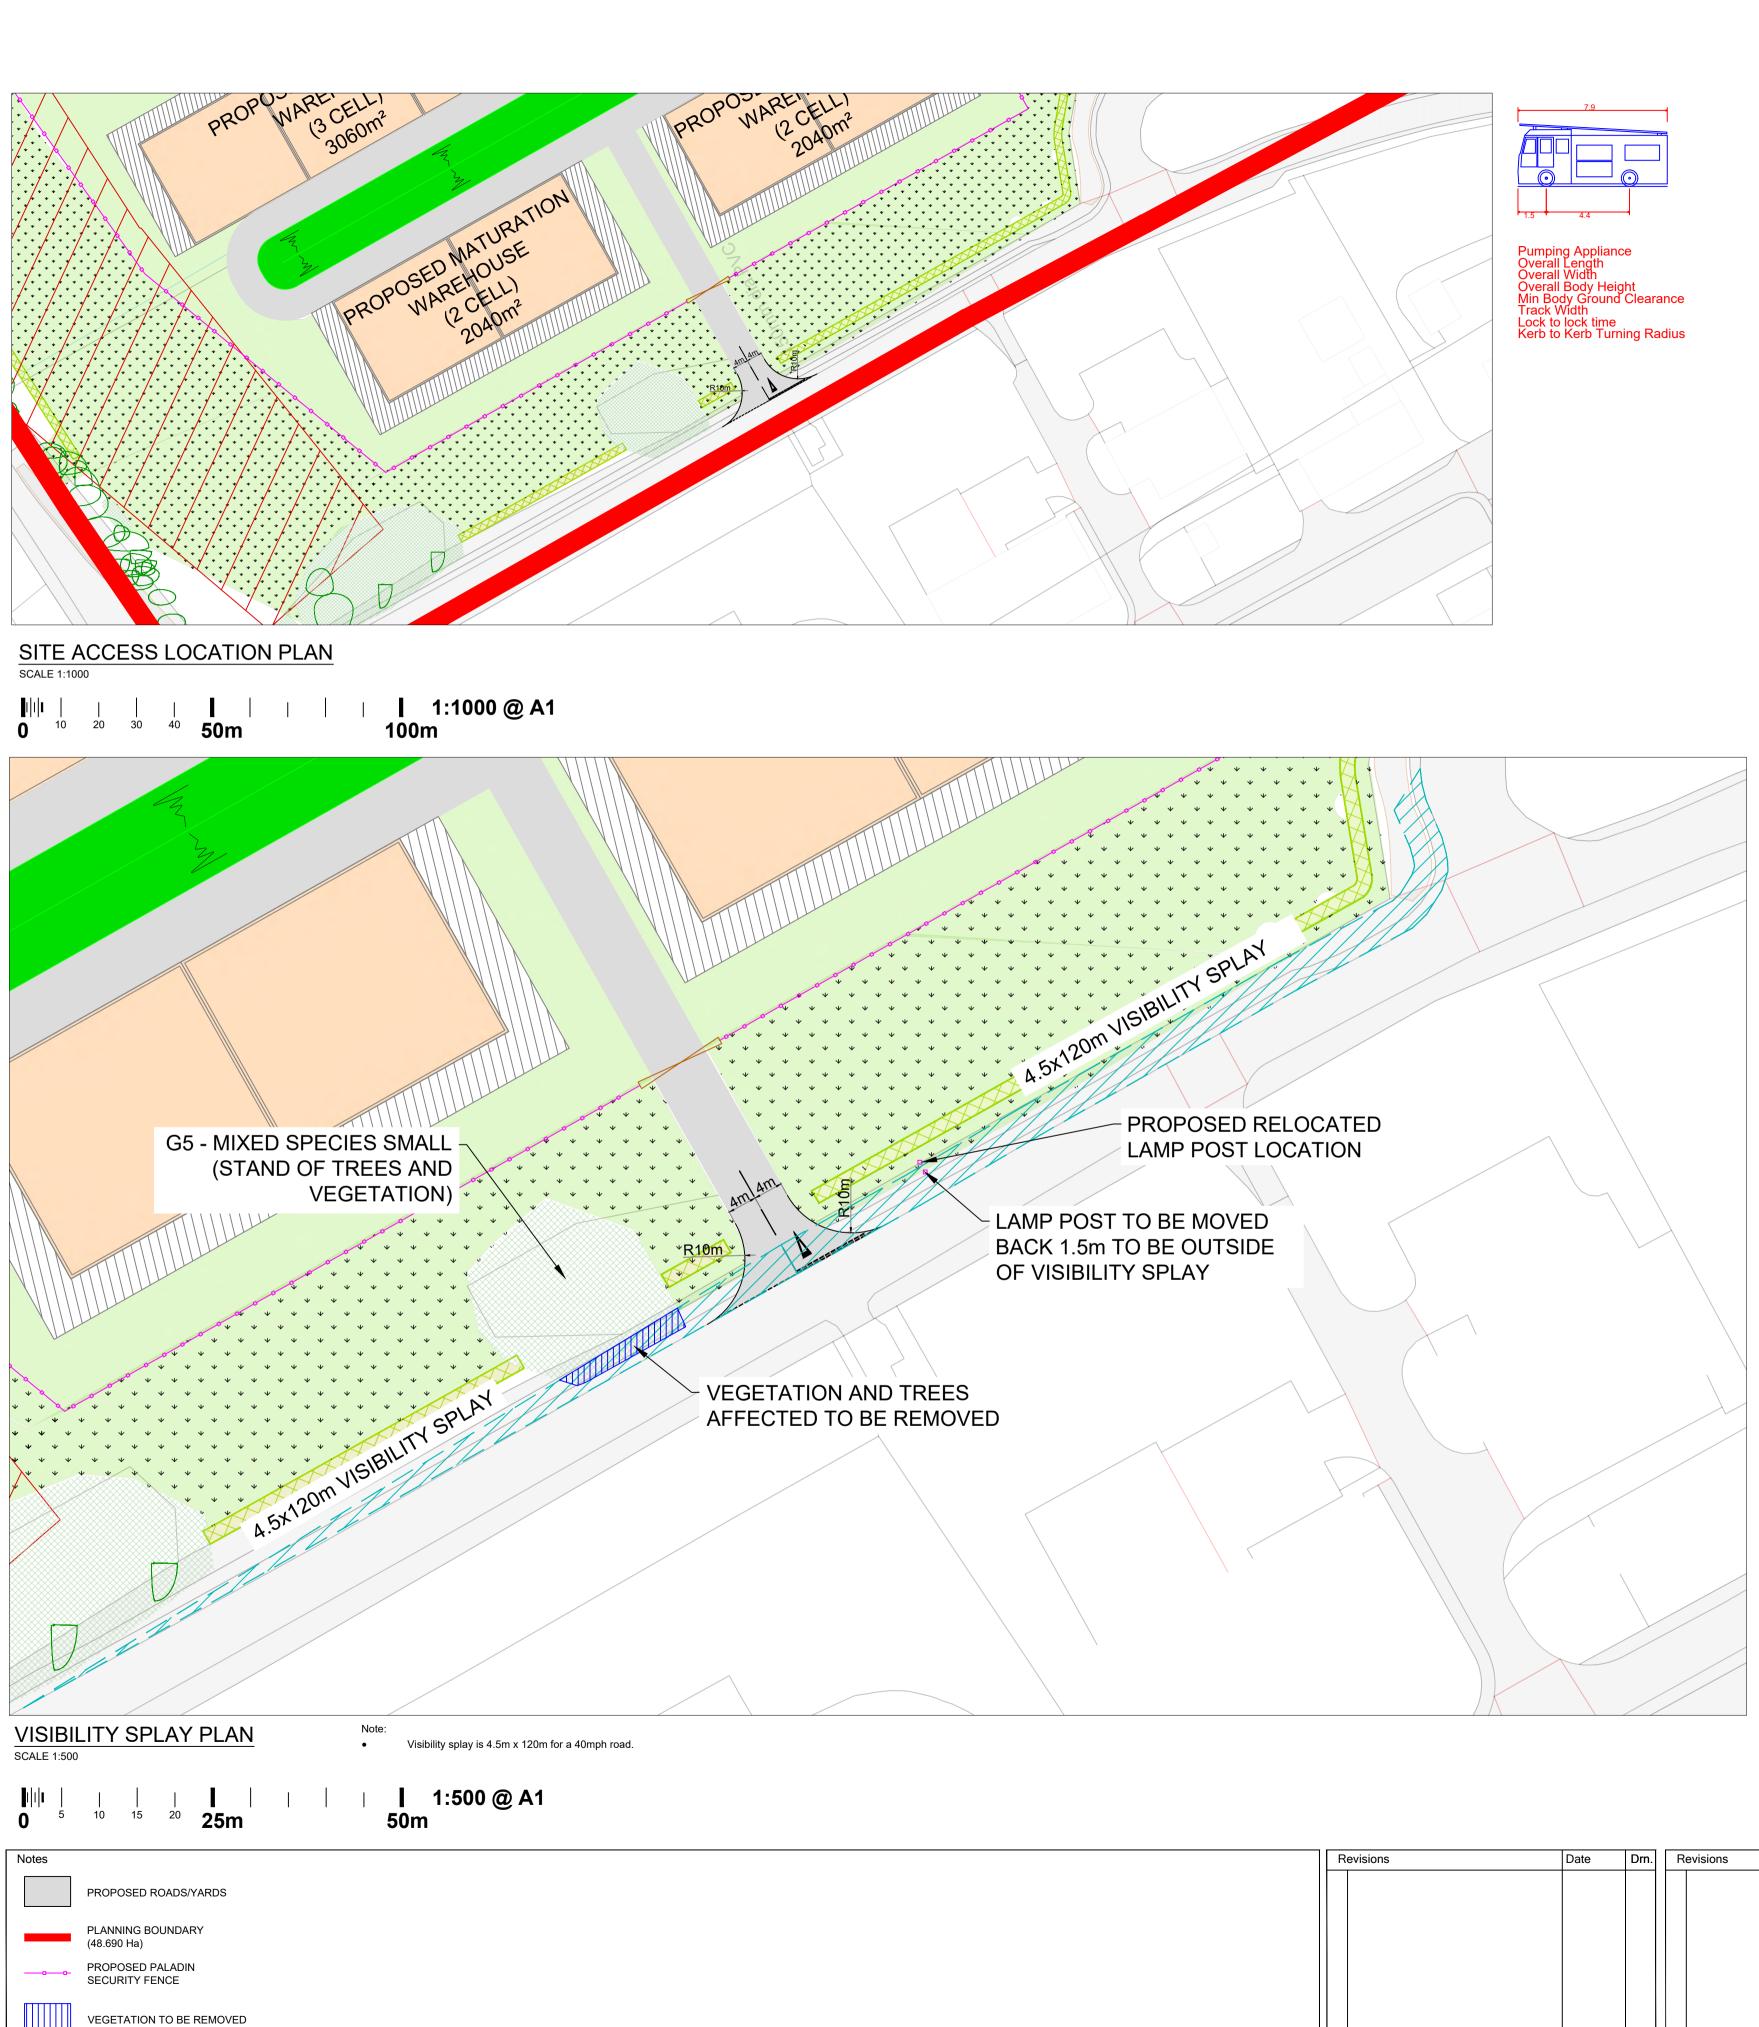


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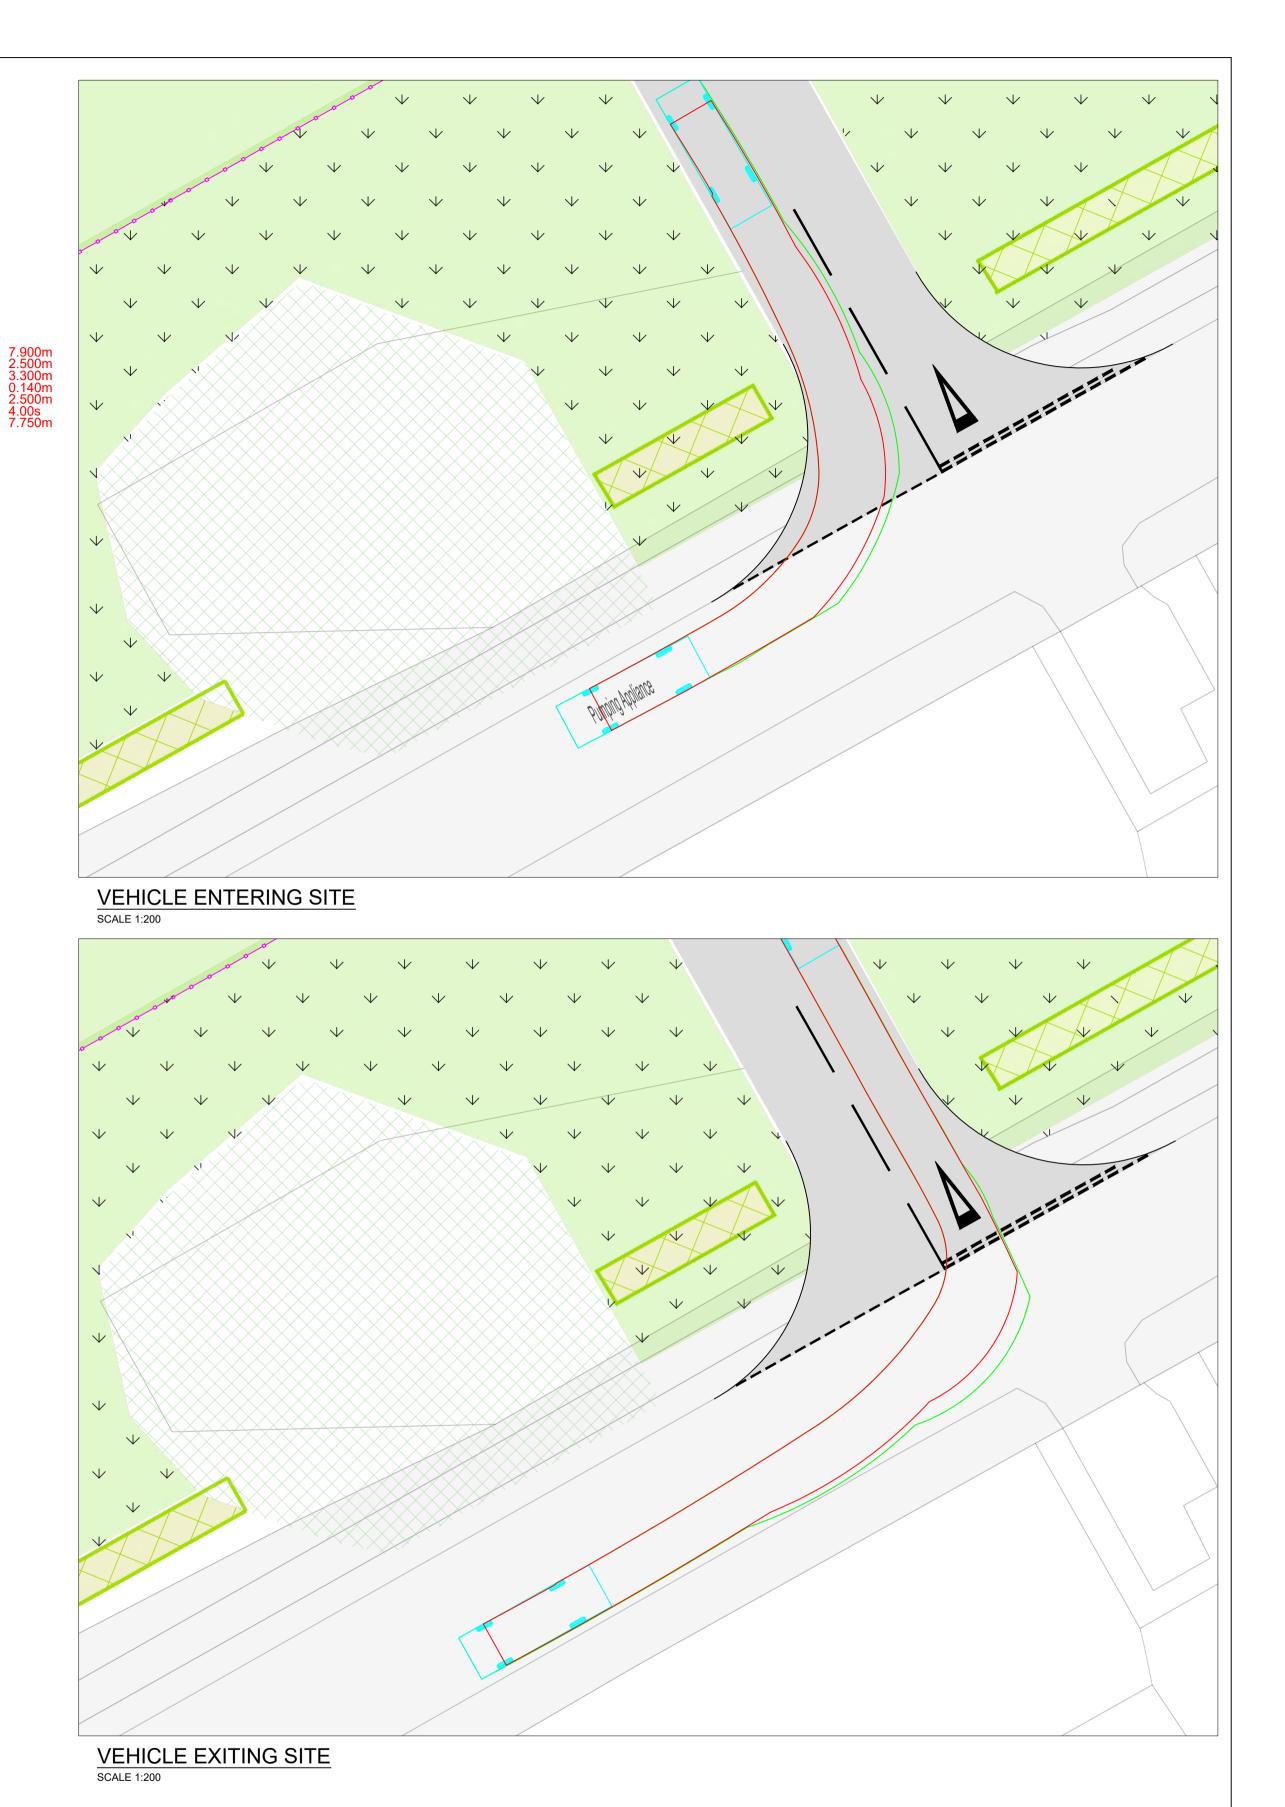
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| BLYTH&E | BLYTH | | CESS AND MAIN SITE A | VISIBILITY SPLAY ACCESS |
|--|-------|-------------|--|-----------------------------------|
| Cornerstone, 60 South 0 Edinburgh EH12 Email: edinburgh@blythandblyth.co.uk www.blythandblyth.co.uk | 9EB | | Ck'd _{AA} Date: Nov '22 | Scale 1:2500 @ A1 DO NOT SCALE |
| INVERGOR MATURATION WAR | DON | Drawing No. | 08:00:106 | Revision A |



| R | evisions | Date | D | rn. | F | Revisions | Date | Drn. | WHYTE & MACKAY |
|---|----------|------|---|-----|---|-----------|------|------|----------------|
| | | | | | | | | | PLANNING |
| | | | | | | | | | DRAWING |

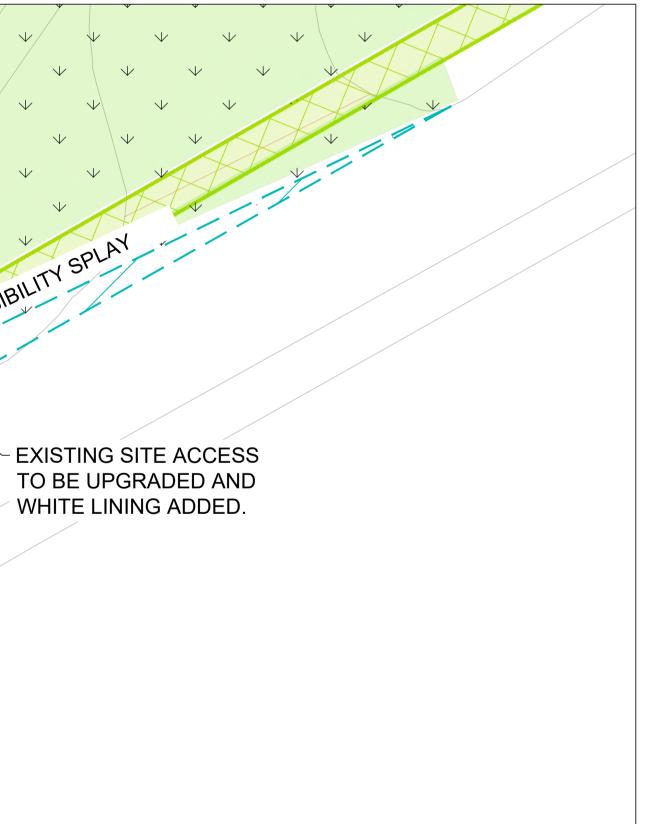


| BLYTH&BLYTH | | | |
|---|----|--|--|
| Cornerstone, 60 South Gyle Crescent Edinburgh EH12 9EB | | | |
| Email: edinburgh@blythandblyth.co.uk www.blythandblyth.co.uk Telephone: 0131 474 270 | 00 | | |

EMERGENCY VEHICLE ACCESS AND VISIBILITY SPLAY

| 9EB | Drawn: EMP | Ck'd _{AA} | Scale AS SHOWN | |
|--------------------------|------------------|--------------------|----------------|--|
| Telephone: 0131 474 2700 | Date: Jan '23 | Date: Jan '23 | DO NOT SCALE | |
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| DON | Drawing No. | Revis | | |
| EHOUSING | EC22808:00:121 - | | | |

DO NOT SCALE Revisior

INVERGORD MATURATION WARE

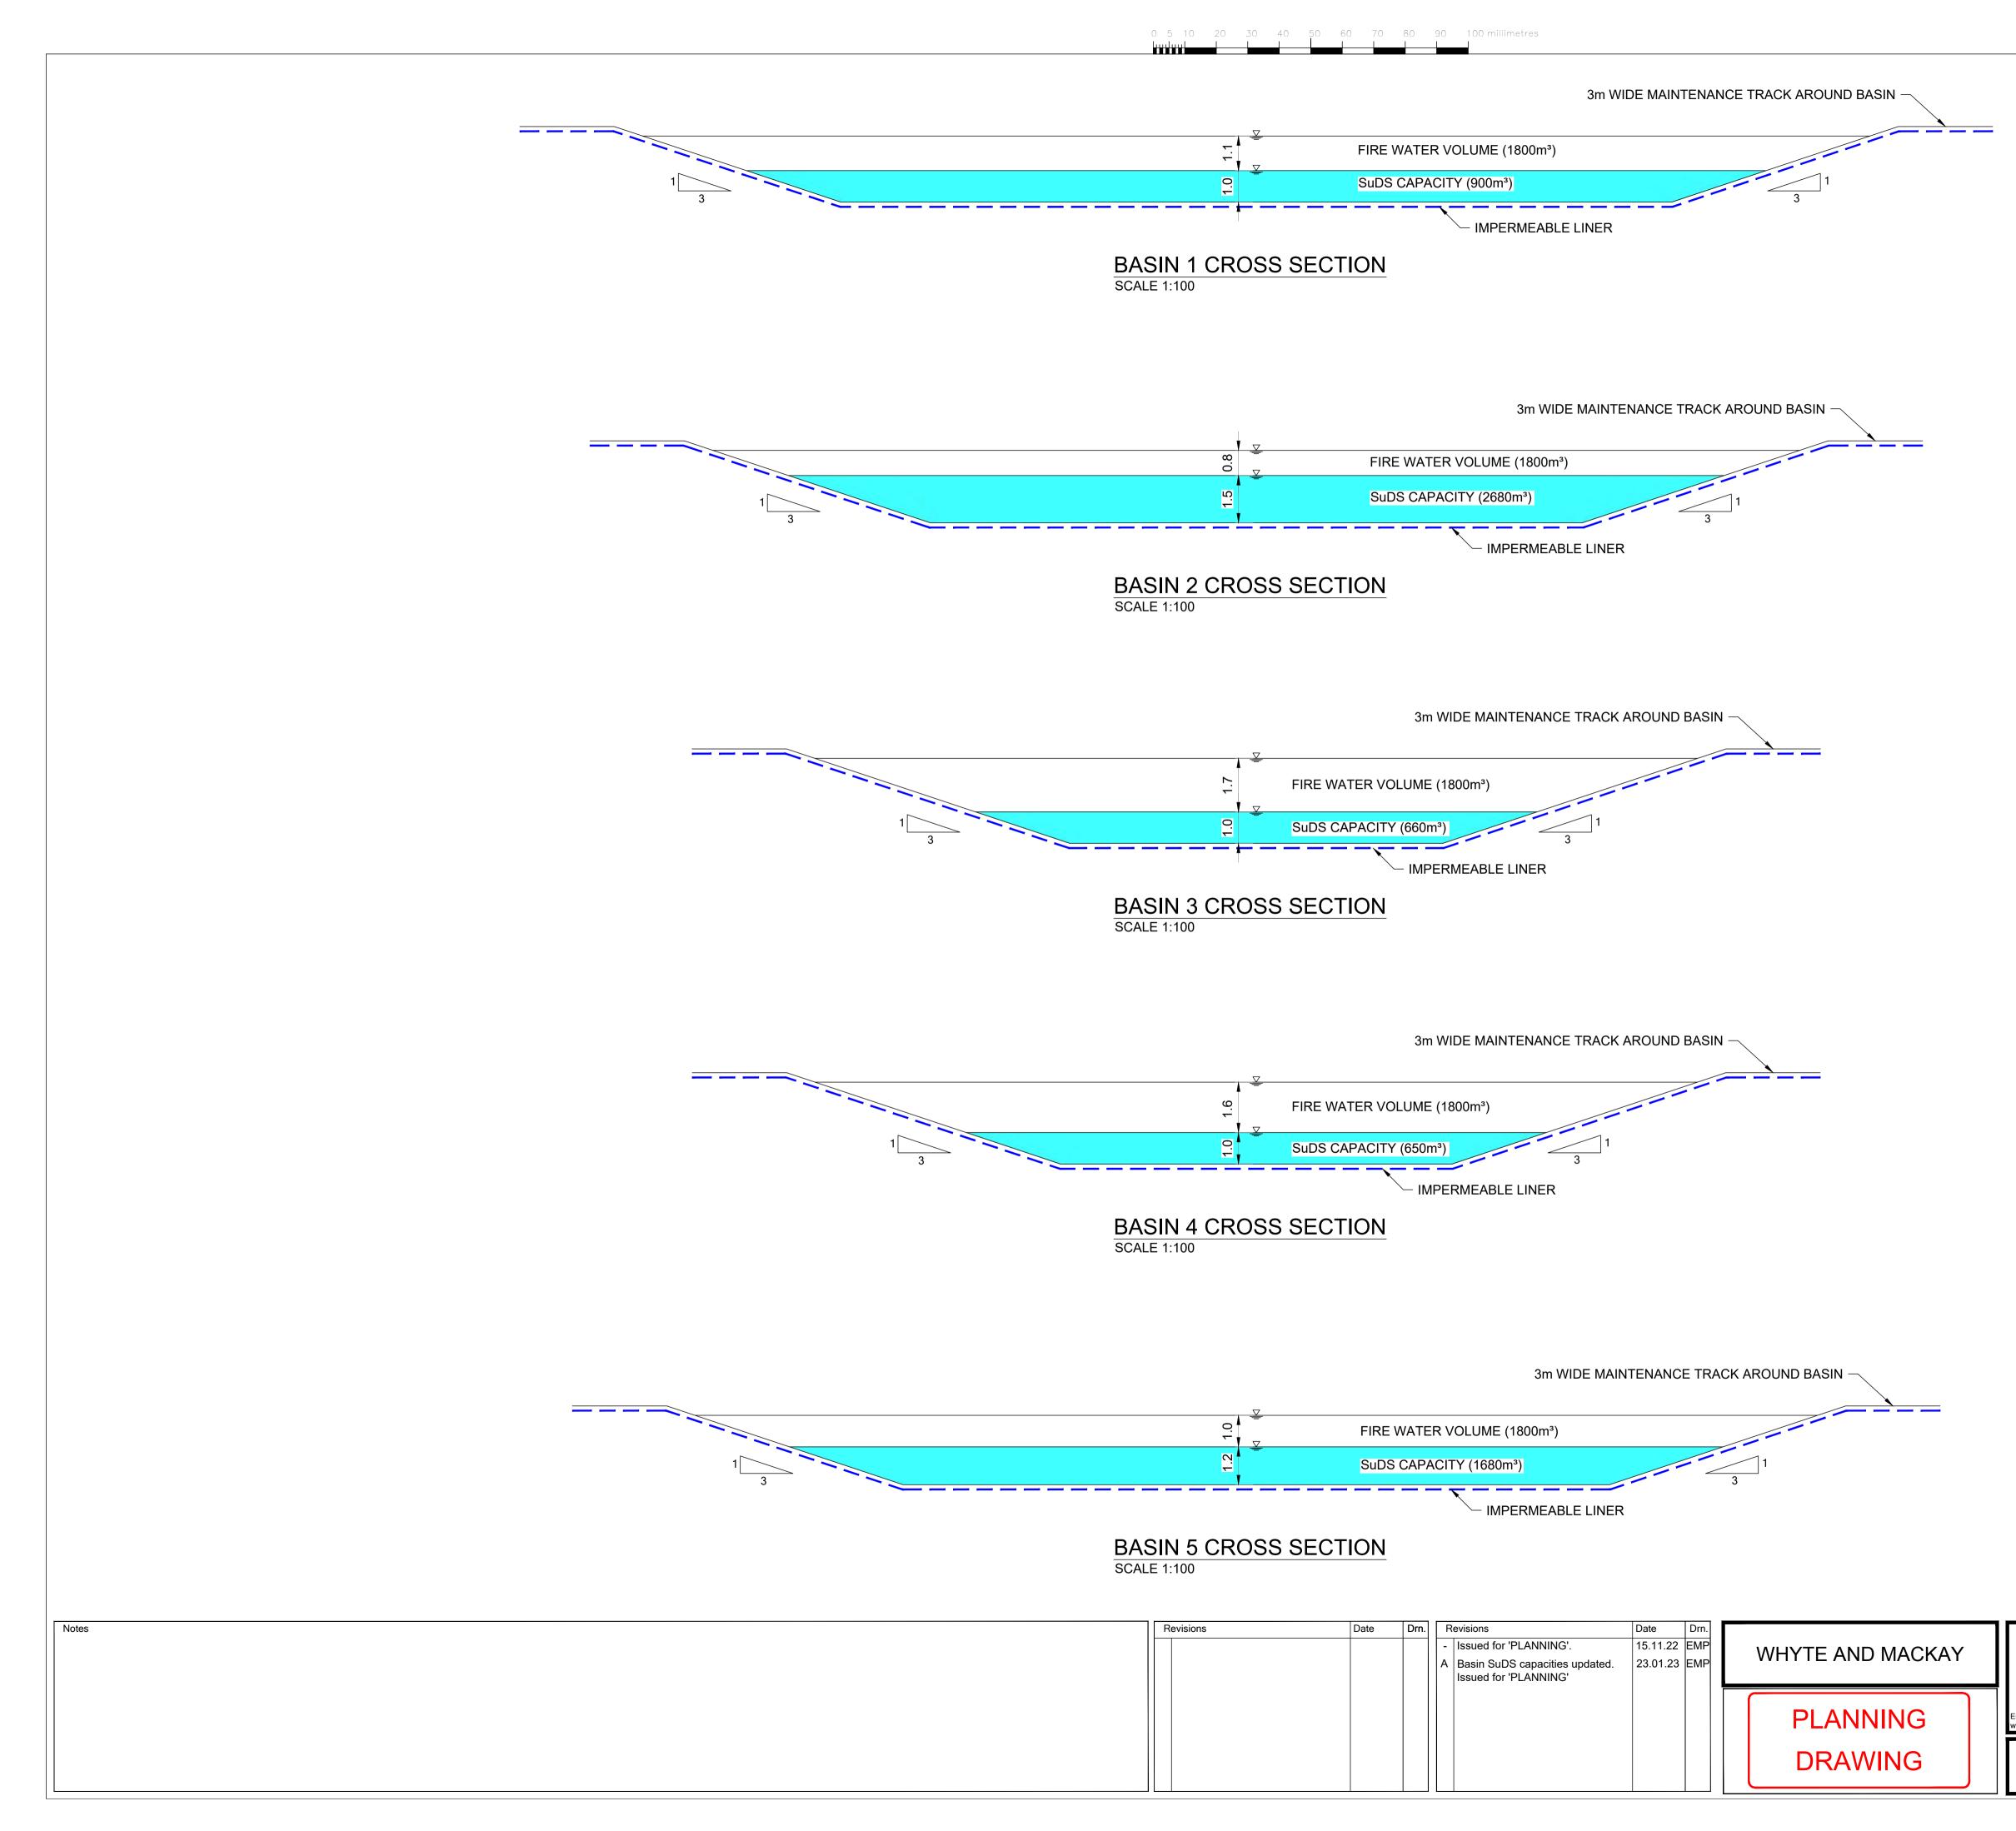

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|----------|------|
| | LYTH |

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INVERGORDON MATURATION WAREHOUSING

PROPOSED SUDS POND CROSS SECTIONS

 Drawn: EMP
 Ck'd
 Scale
 1:100 @ A1

 Date:
 Nov '22
 Date:
 DO NOT SCALE

 Drawing No.
 Revision

 EC22808:00:105
 A



| DRAIN/ | AGE | NETW | ORK | 1 |
|--------------|----------------|------------|------------------|---------------------------|
| US/MH Name | US/CL (m) | U\$/IL (m) | Pipe DIA (mm) | US/MH Diam/Len (mm) |
| 1 | 11.500 | 10.000 | 225 | 1200 |
| 2 | 1 1.500 | 9.789 | 300 | 1200 |
| 3 | 10.700 | 9.500 | 450 | 1350 |
| 4 | 10.700 | 9.044 | 450 | 1350 |
| swale | 10.600 | 9.800 | swale | |
| 5 | 10.600 | 8.852 | 450 | 1500 |
| 6 | 10.500 | 9.200 | 450 | 1350 |
| 7 | 10.500 | 8.660 | 450 | 1350 |
| 8 | 10.000 | 8.700 450 | | 1350 |
| 9 | 10.000 | 8.094 | 600 | 1500 |
| swale | 9.900 | 9.000 | swale | |
| 10 | 9,900 | 7.910 | 600 | 1500 |
| 1 1 | 9.800 | 8.500 | 450 | 1350 |
| 12 | 9.800 | 7.718 | 600 | 1500 |
| 13 | 9.000 | 7.700 | 450 | 1350 |
| 14 | 9.000 | 7.094 | 600 | 1500 |
| swale | 9.000 | 8.200 | swale | |
| 15 | 9.000 | 6.760 | 750 | 1500 |
| 16 | 9.000 | 7.700 | 450 | 1350 |
| 17 | 9.000 | 7.300 | 450 | 1350 |
| swale | 9.000 | 8.200 | swale | |
| 18 | 9.000 | 7.128 | 450 | 1350 |
| Basin 1 | 9.000 | 6.544 | 750 | 1800 |
| Hydrobrake 1 | 9.000 | 6.436 | 750 | 1800 |

| DRAIN/ | AGE I | NETW | ORK | 3 | | |
|--------------|--------------|-----------|------------------|---------------------------|--|--|
| US/MH Name | US/CL (m) | US/IL (m) | Pipe DIA (mm) | US/MH Diam/Len (mm) | | |
| 100 | 7.350 | 6.300 | 600 | 1500 | | |
| 101 | 7.350 | 5.820 | 600 | 1500 | | |
| 102 | 7.716 | 6.500 | 600 | 1500 | | |
| 103 | 7.160 | 6.020 | 600 | 1500 | | |
| swale | 7.160 | 6.400 | swale | | | |
| swale | 7.160 | 5.730 | swale | | | |
| 104 | 7.350 | 6.500 | 375 | 1350 | | |
| 105 | 7.350 | 6.280 | 375 | 1350 | | |
| 106 | 7.160 | 5.466 | 900 | 1200 | | |
| 107 | 7.160 | 6.000 | 600 | 1500 | | |
| 108 | 7.160 | 5.780 | 600 | 1500 | | |
| 109 | 7.160 | 5.396 | 900 | | | |
| Basin 3 | 7.160 | 5.320 | 900 | 1800 | | |
| Hydrobrake 3 | 7.160 | 5.220 | 900 | 1800 | | |

| | | | | | | |
|-----------|----------|-------|--|----------|------|------------------|
| Revisions | Date Drn | . F | Revisions | Date | Drn. | |
| | | - | Issued for 'PLANNING'. | 15.11.22 | EMP | WHYTE AND MACKAY |
| | | A | Basin SuDS capacities updated. Issued for 'PLANNING' | 23.01.23 | EMP | |
| | | В | Ditch diversion added. Sewer diversion | 27.01.23 | EMP | |
| | | | and Tank, Switchroom and Pumphouse locations altered. Issued for | | | PLANNING |
| | | | 'PLANNING' | | | PLAINING |
| | | | | | | |
| | | | | | | DRAWING |
| | | | | | | |

| US/MH Name | US/CL (m) | US/IL (m) | Pipe DIA (mm) | US/MH Diam/Len (mm) | | |
|--------------|----------------|-----------|------------------|---------------------------|--|--|
| 50 | 10.300 | 9.000 | 450 | 1350 | | |
| 51 | 10.300 | 8.656 | 450 | 1350 | | |
| 52 | 10.300 | 8.312 | 450 | 1350 | | |
| swale | 10.150 | 9.300 | 750 | | | |
| swale | 10.150 | 8.132 | 750 | 1350 | | |
| 53 | 10.000 | 8.700 | 450 | 1350 | | |
| 54 | 10.000 | 8.220 | 450 | 1350 | | |
| 55 | 10.000 | 7.740 | 450 | 1350 | | |
| swale | 10.150 | 7.556 | 750 | | | |
| 56 | 10.500 | 9.200 | 300 | 1200 | | |
| 57 | 57 10.500 8.89 | | 300 | 1200 | | |
| swale | 10.150 | 7.156 | 750 | 1200 | | |
| 58 | 10.150 | 7.059 | 750 | | | |
| 59 | | | 450 | 1350 | | |
| 60 | 10.000 | 6.871 | 750 | 1800 | | |
| 61 | 8.800 | 7.500 | 375 | 1350 | | |
| 62 | 8.800 | 6.779 | 750 | 1800 | | |
| swale | 8.750 | 7.900 | 750 | | | |
| 63 | 9.000 | 7.800 | 450 | 1350 | | |
| 64 | 9.000 | 7.320 | 450 | 1350 | | |
| 65 | 9.000 | 6.840 | 600 | 1500 | | |
| 66 | 8.500 | 7.500 | 600 | 1500 | | |
| 67 | 8.500 | 7.100 | 600 | 1500 | | |
| 68 | 8.500 | 6.700 | 600 | 1500 | | |
| swale | 8.750 | 6.550 | 750 | | | |
| 69 | 8.300 | 6.800 | 600 | 1500 | | |
| 70 | 8.300 | 6.360 | 750 | 1500 | | |
| 71 | 8.500 | 6.117 | 1200 | 1350 | | |
| 72 | 8.500 | 6.034 | 1200 | 2100 | | |
| Basin 2 | 8.500 | 5.924 | 1200 | 2100 | | |
| Hydrobrake 2 | 8.500 | 5.757 | 1200 | 2100 | | |

| US/MH Name | US/CL (m) | US/IL (m) | Pipe DIA (mm) | US/MH Diam/Len (mm) | | |
|--------------|--------------|-----------|------------------|---------------------------|--|--|
| 120 | 7.160 | 6.300 | 600 | 1500 | | |
| 121 | 7.160 | 5.820 | 600 | 1500 | | |
| 122 | 7.350 | 6.500 | 600 | 1500 | | |
| 123 | 7.350 | 6.020 | 600 | 1500 | | |
| swale | 7.160 | 6.400 | swale | | | |
| swale | 7.160 | 5.730 | swale | | | |
| 124 | 7.350 | 6.300 | 450 | 1350 | | |
| 125 | 7.350 | 6.080 | 450 | 1350 | | |
| 126 | 7.160 | 5.466 | 900 | 1200 | | |
| 127 | 7.160 | 6.000 | 600 | 1500 | | |
| 128 | 7.160 | 5.376 | 900 | 1800 | | |
| Basin 4 | 7.160 | 5.344 | 750 | 1800 | | |
| Hydrobrake 4 | 7.160 | 5.244 | 750 | 1800 | | |

| US/MH Name | US/CL (m) | US/IL (m) | Pipe DIA (mm) | US/MH Diam/Len (mm) | | |
|--------------|-----------------|-----------------|------------------|---------------------------|--|--|
| 150 | 150 7.160 6.300 | | 600 | 1500 | | |
| 151 | 7.160 | 5.820 | 600 | 1500 | | |
| 152 | 7.160 | 6.300 | 600 | 1500 | | |
| 153 | 7.160 | 5.820 | 600 | 1500 | | |
| swale | 7.160 | 6.400 | swale | 1.0.0 | | |
| 154 | 7.160 | 5.730 | 750 | 1500 | | |
| 155 | 7.160 | 5.680 | 750 | 1500 | | |
| 156 | 7.160 | 5.416 | 1200 | 1500 | | |
| 157 | 7.160 | 6.000 | 600 | 1500 | | |
| 158 | 7.160 | 7.160 5.780 600 | | 1500 | | |
| swale | 7.160 | 6.400 | swale | | | |
| 159 | 7.160 | 6.300 | 600 | 1500 | | |
| 160 | 7.160 | 5.820 | 600 | 1500 | | |
| swale | 7.160 | 5.730 | swale | | | |
| 161 | 7.160 | 5.326 | 1200 | 1500 | | |
| 162 | 8.350 | 7.500 | 450 | 1350 | | |
| 163 | 8.350 | 7.000 | 450 | 1350 | | |
| swale | 8.200 | 7.400 | swale | | | |
| 164 | 8.200 | 6.904 | 450 | 1500 | | |
| 165 | 8.150 | 7.000 | 450 | 1350 | | |
| 166 | 8.150 | 6.860 | 450 | 1350 | | |
| swale | 8.150 | 7.300 | swale | | | |
| 167 | 8.150 | 6.790 | 450 | 1350 | | |
| 168 | 7.850 | 6.720 | 450 | 1350 | | |
| 169 | 7.850 | 6.510 | 600 | 1500 | | |
| Basin 5 | 7.160 | 5.294 | 900 | 1800 | | |
| Hydrobrake 5 | 7.160 | 5.194 | 900 | 1800 | | |

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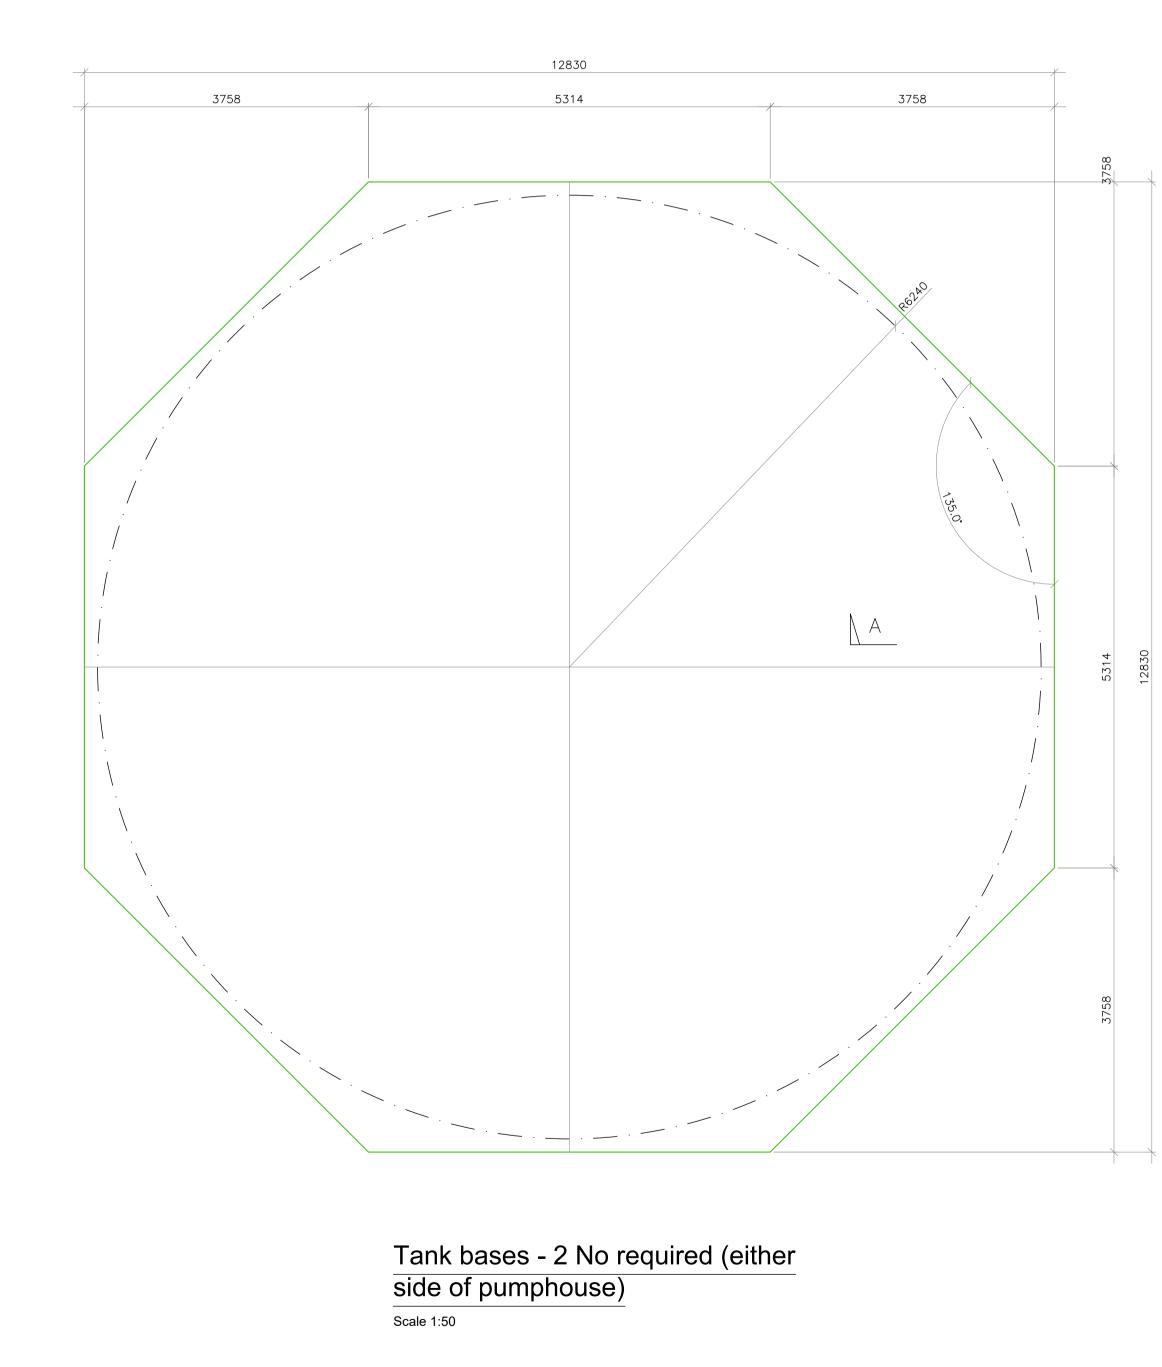
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INVERGORDON

MATURATION WAREHOUSING


PROPOSED DRAINAGE PLAN

| | | 1 |
|---------------|--------------------|-------------------|
| Drawn: EMP | Ck'd _{AA} | Scale 1:2000 @ A1 |
| Date: Nov '22 | Date: Nov '22 | DO NOT SCALE |
| | | |
| Drawing No. | | Revision |
| EC2280 | 8:00:104 | В |




1. Allow 25mm chamfer to all exposed concrete edges.

2. Concrete to be Grade C35

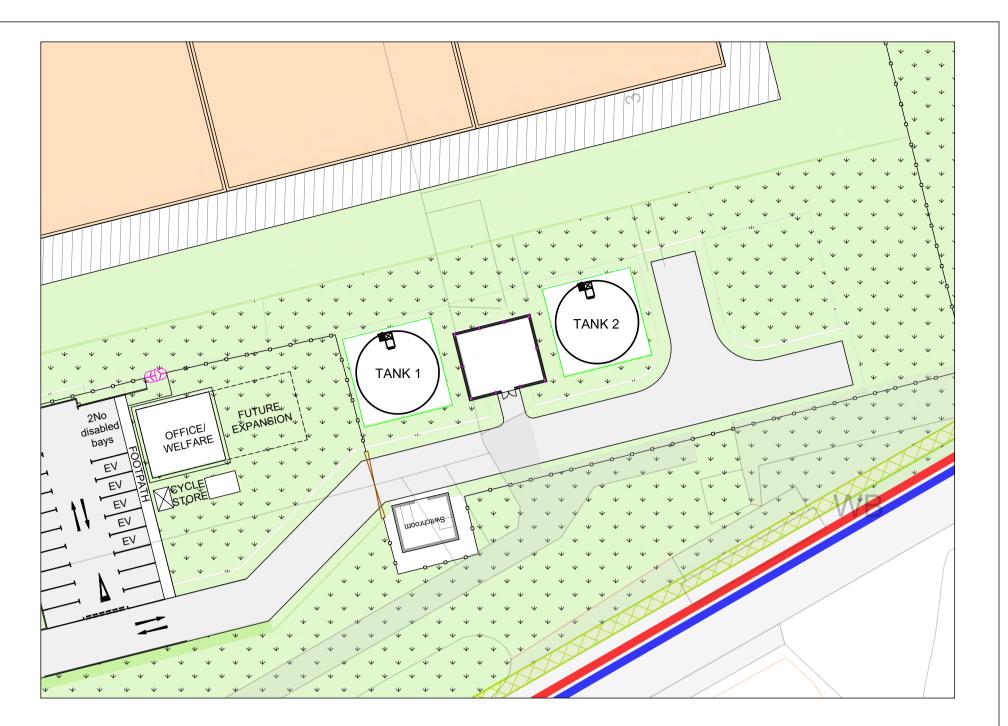




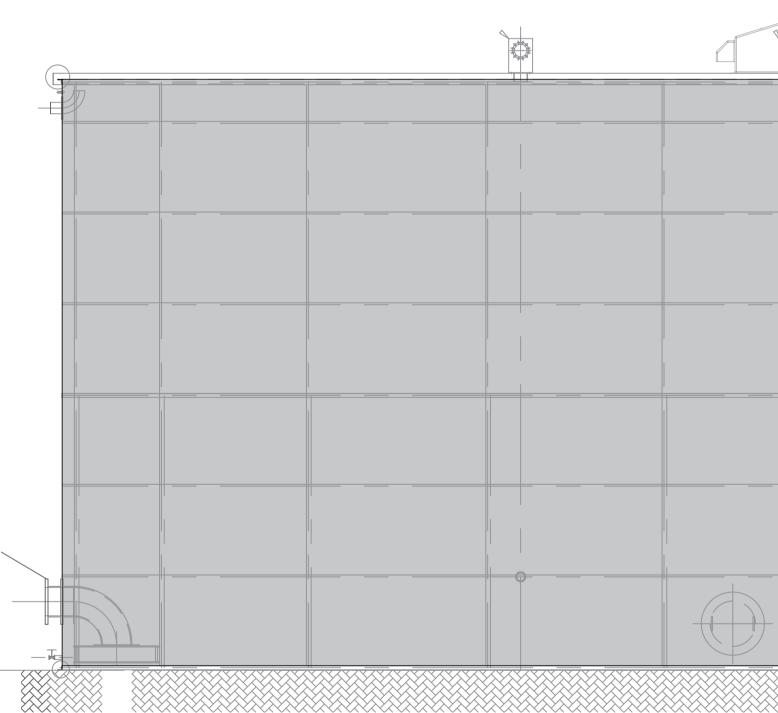

Stainless Steel Tank Elevation Scale 1:50

| Revisions | Date | Drn. | Revisions | Date | Drn. | |
|-----------|------|------|-----------|------|------|------------------|
| | | | | | | WHYTE AND MACKAY |
| | | | | | | PLANNING |
| | | | | | | DRAWING |


_____A

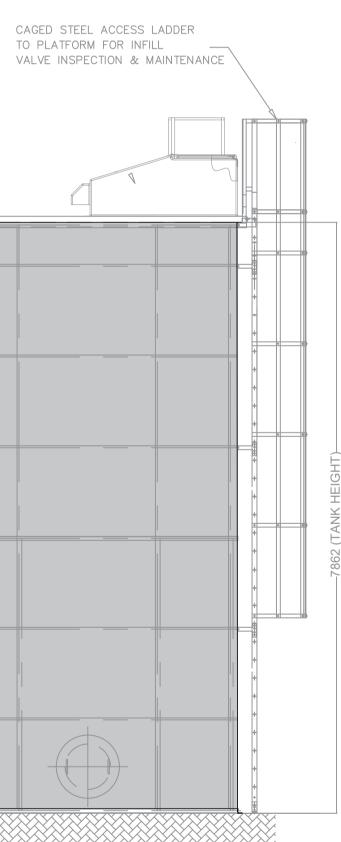

| | BLYTH & | BLYTH | | | | | | | |
|--|---|--------------------------|--|--|--|--|--|--|--|
| | Cornerstone, 60 South Gyle Crescent Edinburgh EH12 9EB | | | | | | | | |
| | Email: edinburgh@blythandblyth.co.uk www.blythandblyth.co.uk | Telephone: 0131 474 2700 | | | | | | | |
| | INVERGORDON | | | | | | | | |
| | INVERGU | RDUN | | | | | | | |


| STORAGE TANK |
|-------------------|
| LAYOUT AND DETAIL |

Scale AS SHOWN @ A1 Ck'd _{AA} Drawn: EMP Date: Nov '22 Date: Nov '22 Date: DO NOT SCALE Drawing No. Revisio EC22808:00:113

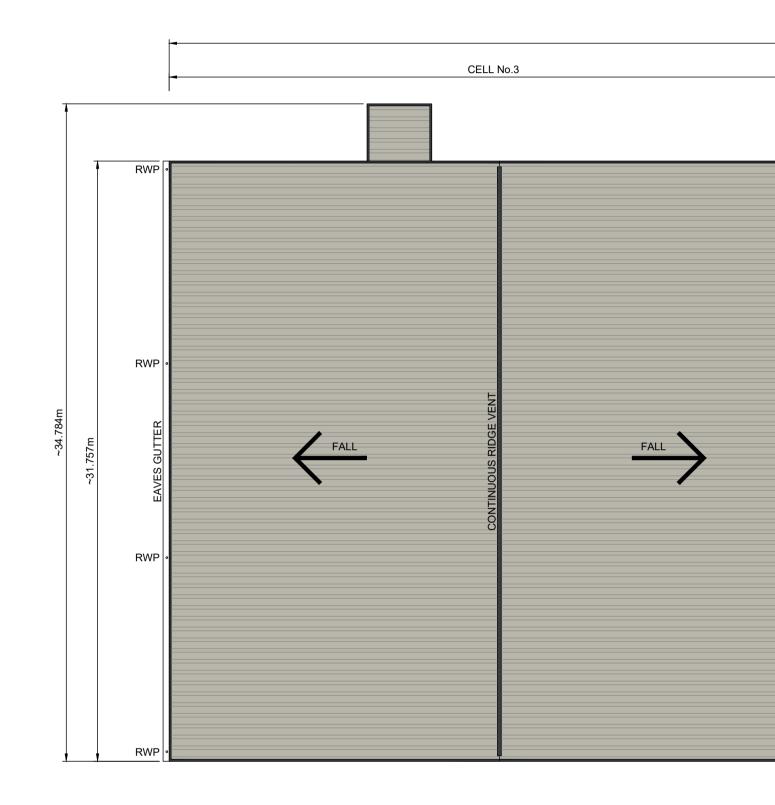


TYPICAL MATURATION WAREHOUSE - ROOF PLAN SCALE 1:200

Notes

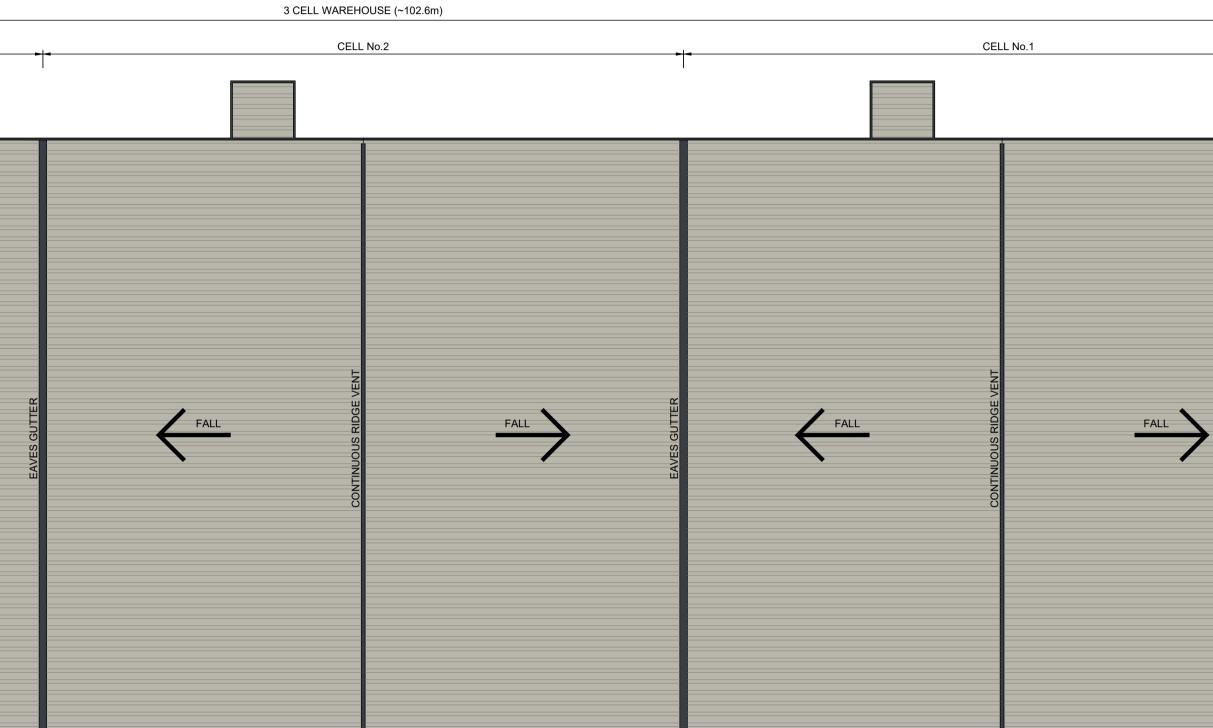

| Revisions | Date | Drn. | Revisions | Date | Drn. | WHYTE AND MACKAY |
|-----------|------|------|-----------|------|------|---------------------|
| | | | | | | PLANNING DRAWING |
| | | | | | | |

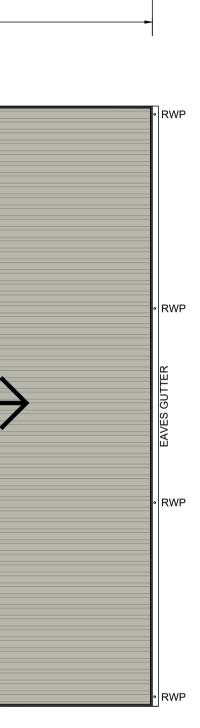


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INVERGORDON MATURATION WAREHOUSING

TYPICAL WAREHOUSE ROOF LAYOUT

Drawn: <u>BMP</u> Ck'd_{AA} Scale 1:200 @ A1 Date: Nov '22 Date: DO NOT SCALE Drawing No. Revision EC22808:00:109 -

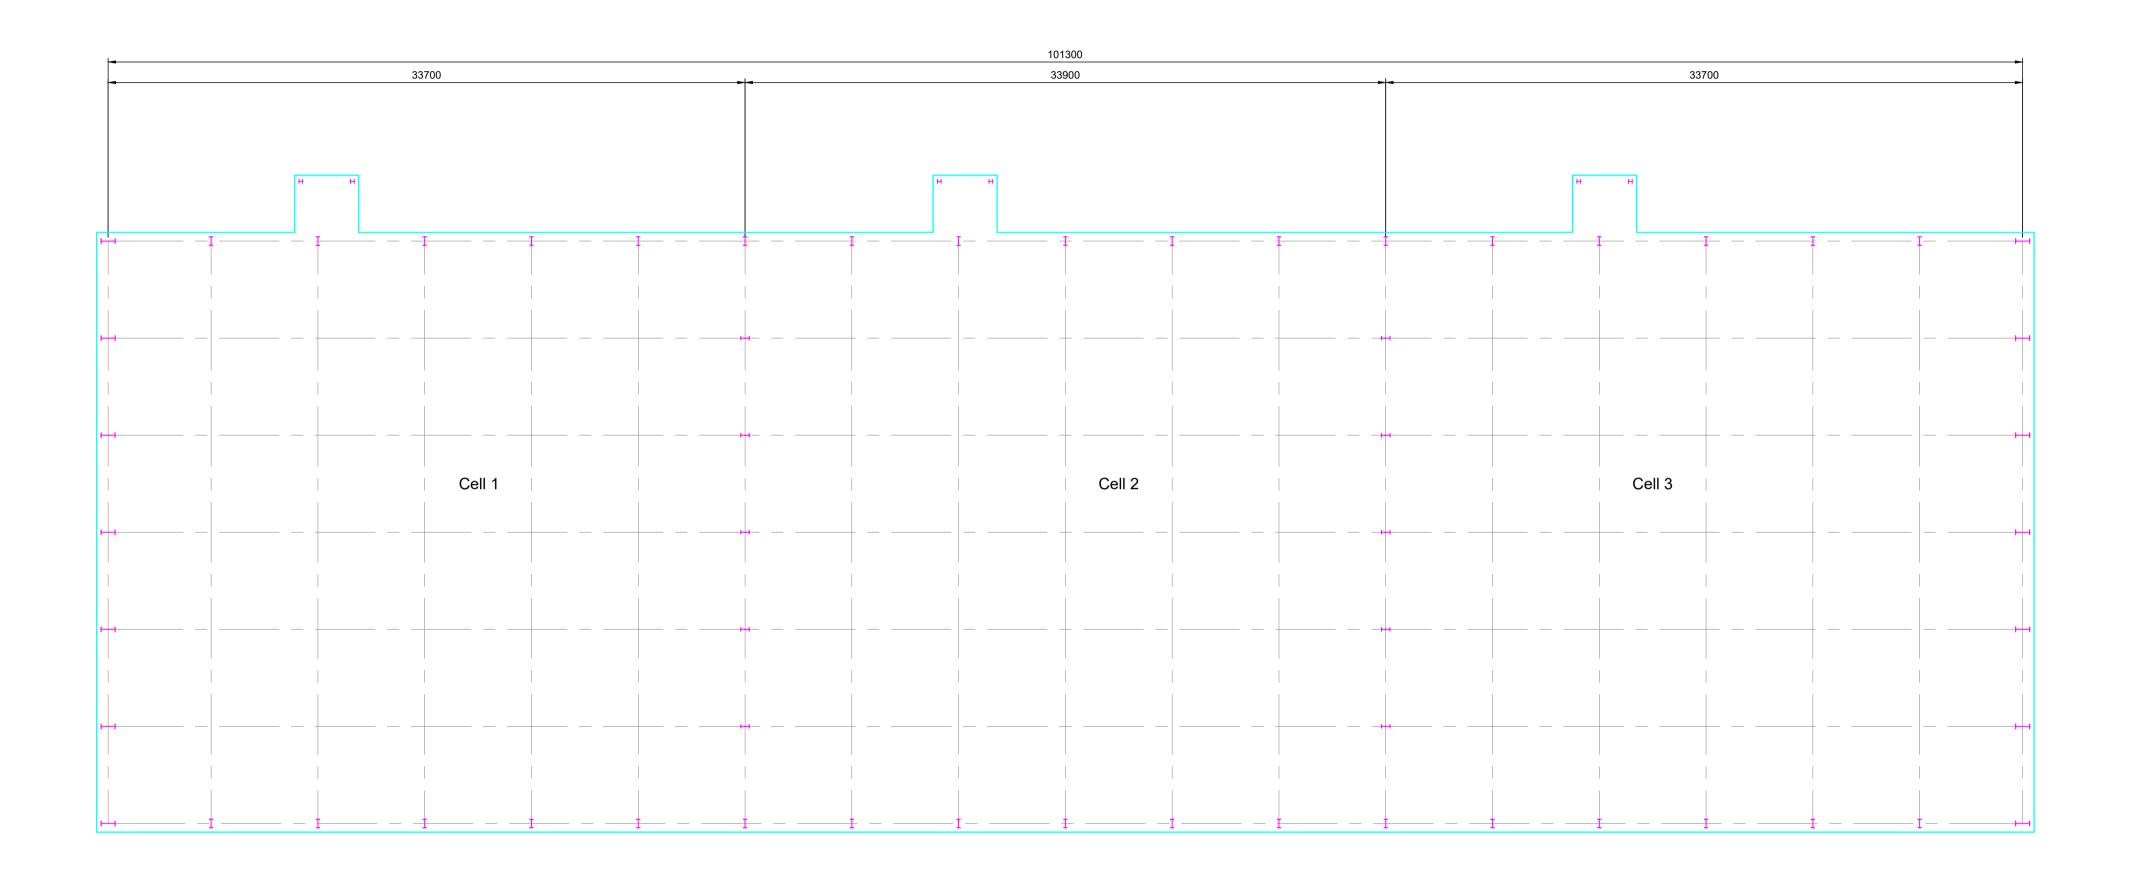

| R | evisions | Date | Drn. | Revisions | Date | Drn. | WHYTE AND MACKAY |
|---|----------|------|------|-----------|------|------|------------------|
| | | | | | | | PLANNING |
| | | | | | | | DRAWING |

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INVERGORDON MATURATION WAREHOUSING


TYPICAL WAREHOUSE GENERAL ARRANGEMENT


Drawn: EMP Ck'd_{AA} Date: Nov '22 Date:

Scale 1:200 @ A1 DO NOT SCALE

Drawing No. EC22808:00:107 Revision


-

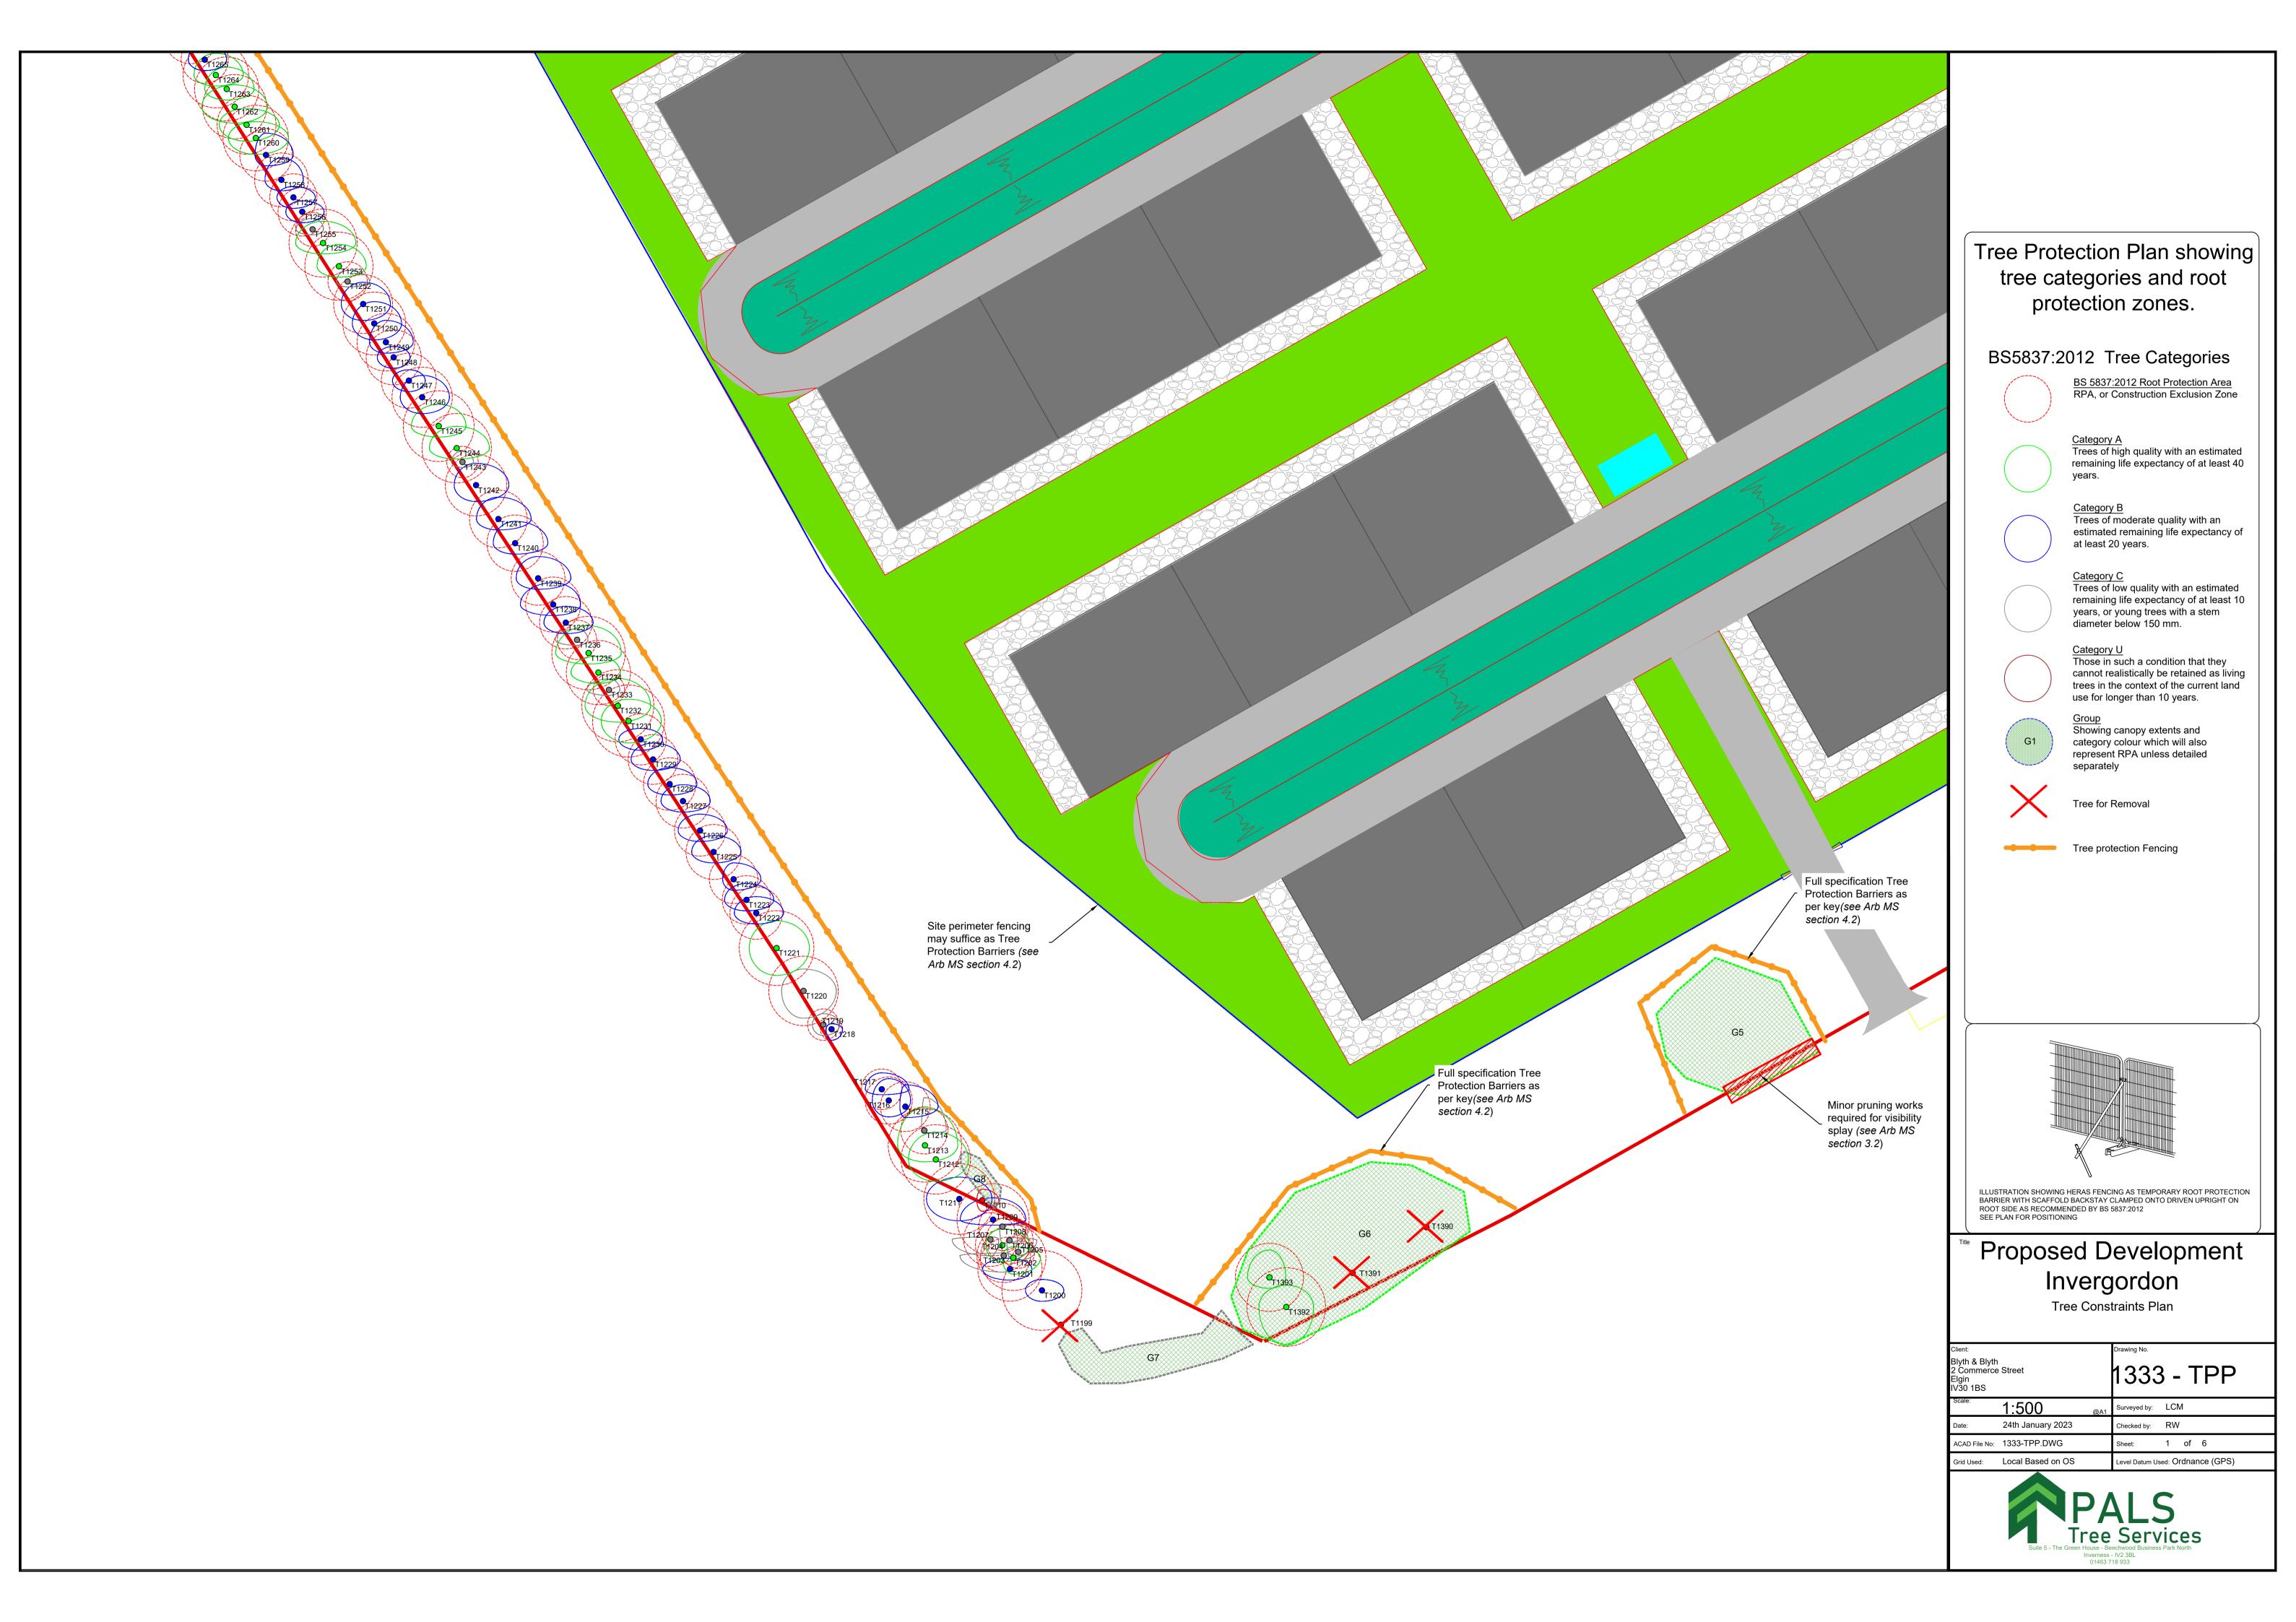

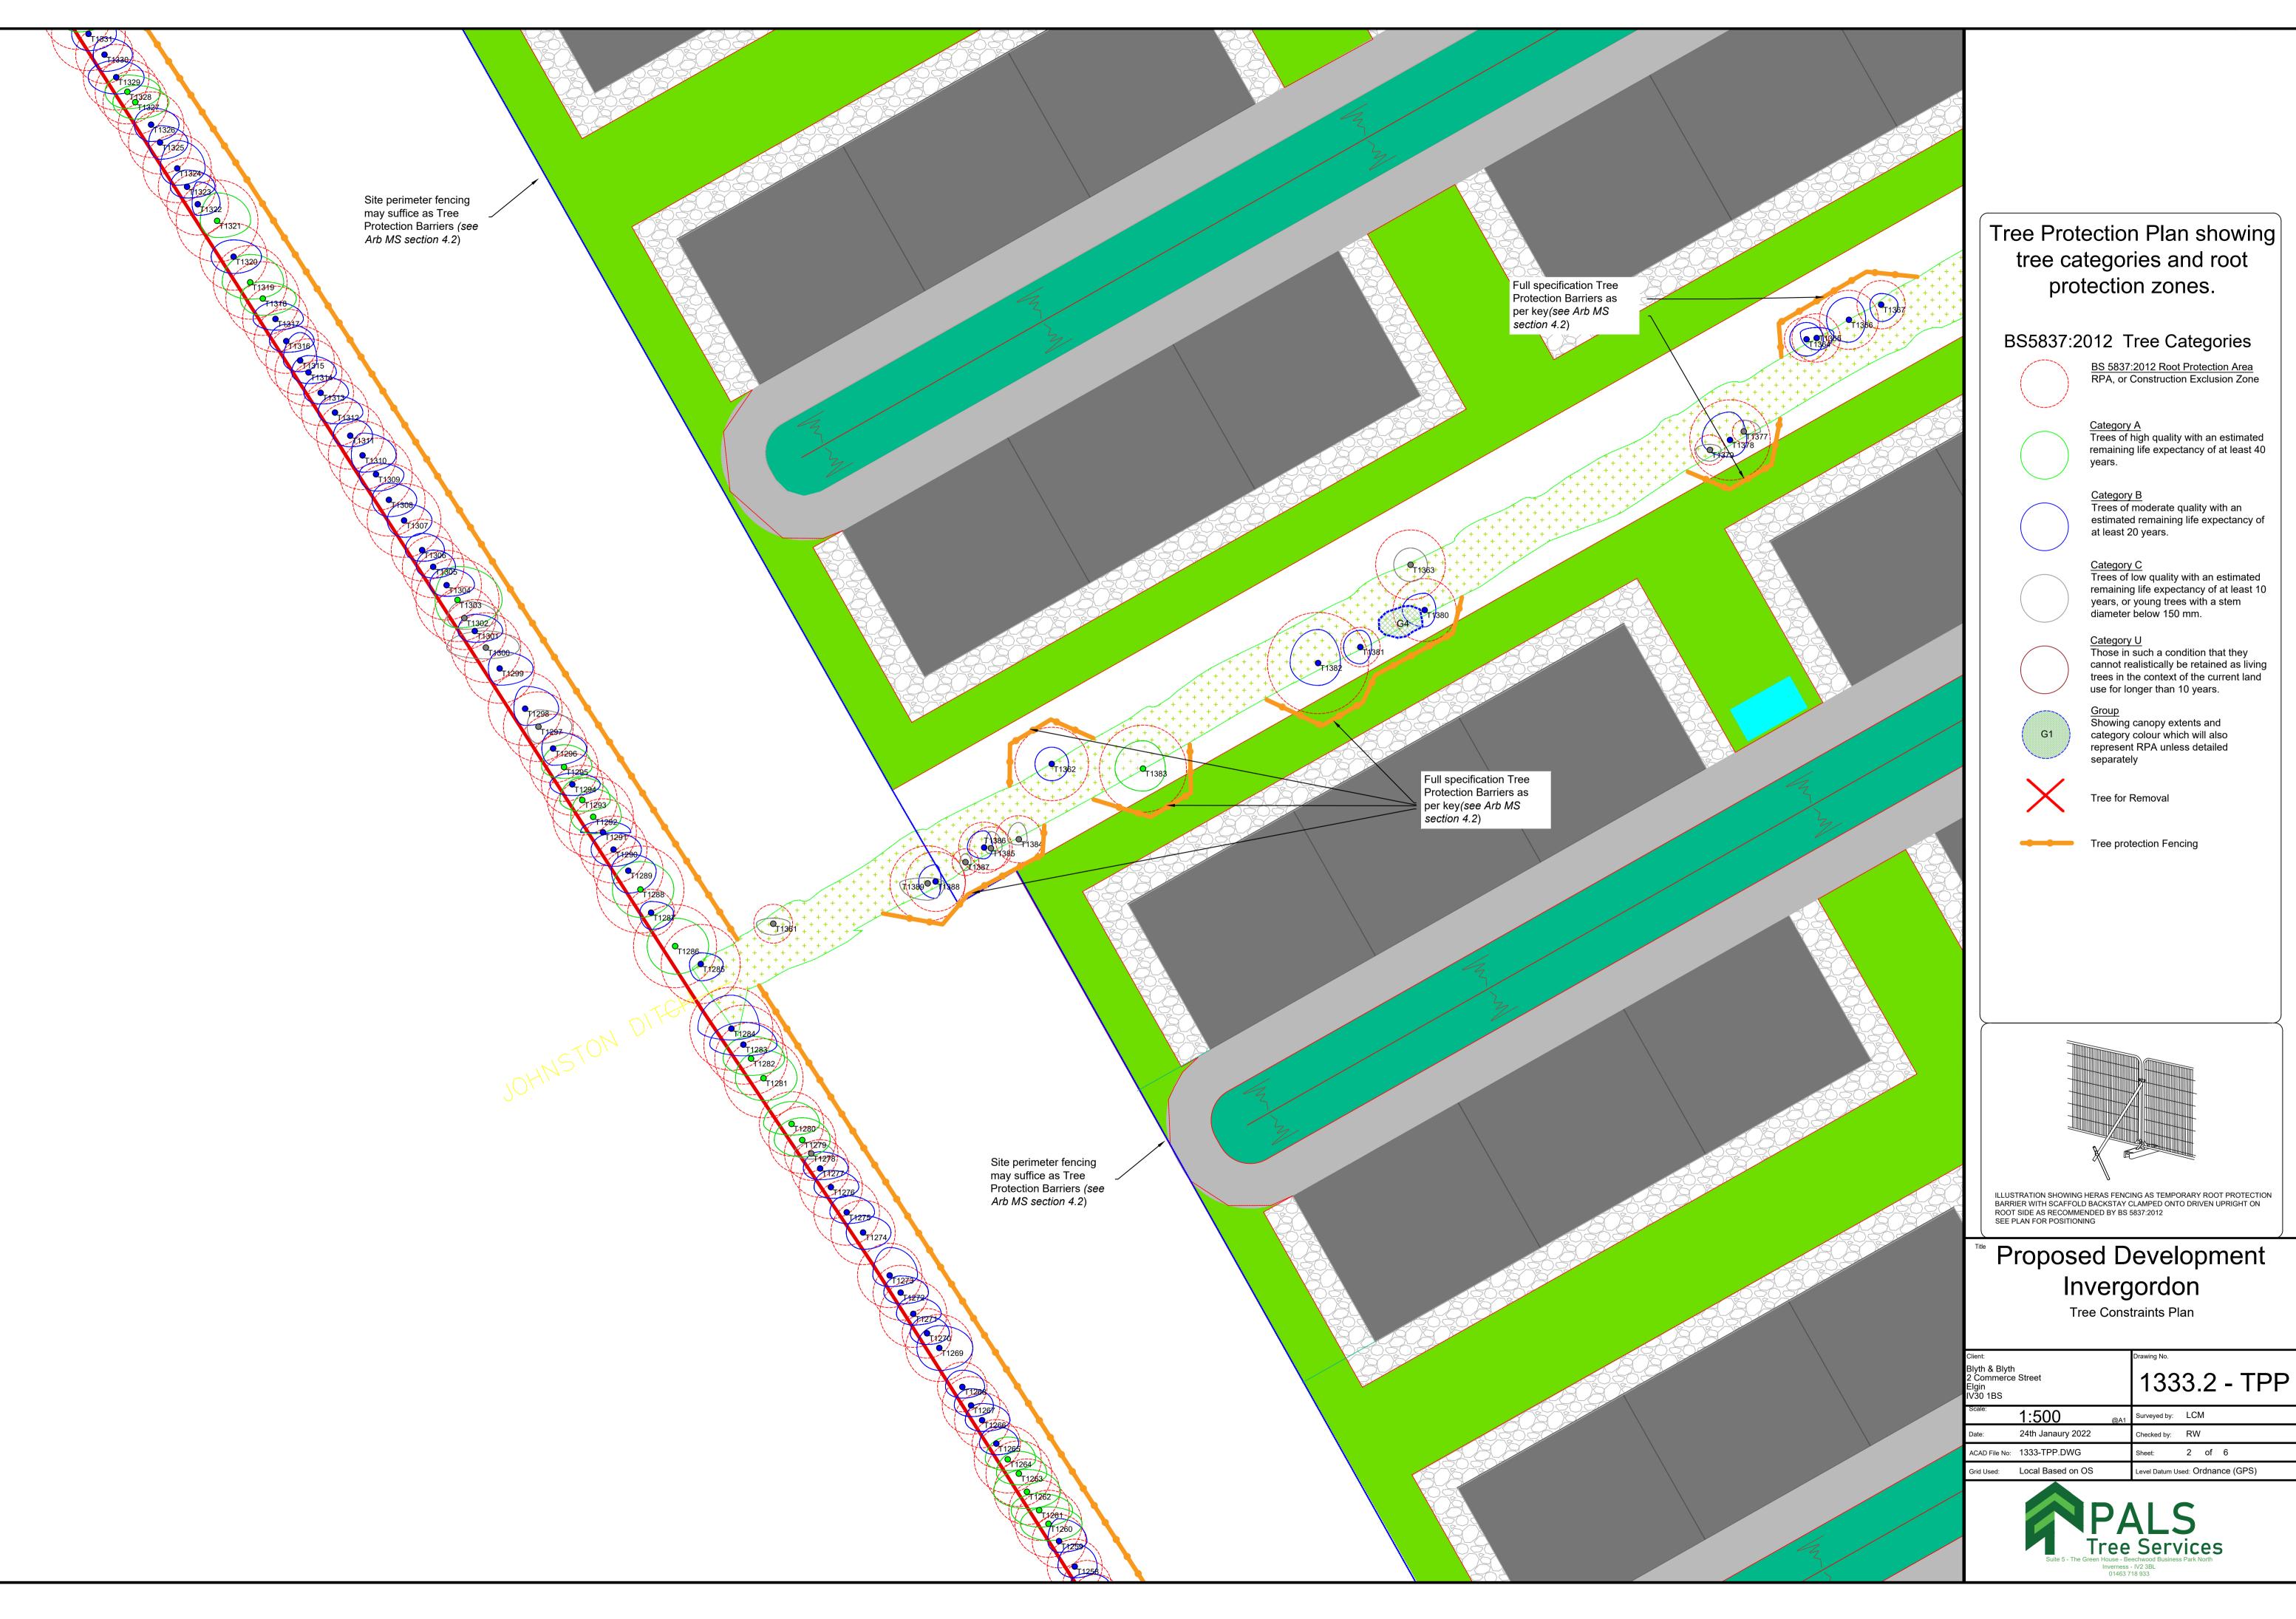

Tree Protection Plan showing

| 2 | , |
|-------------------|----------------------------------|
| No: 1333-TPP.DWG | Sheet: 2 of 6 |
| Local Based on OS | Level Datum Used: Ordnance (GPS) |
| | ALS |

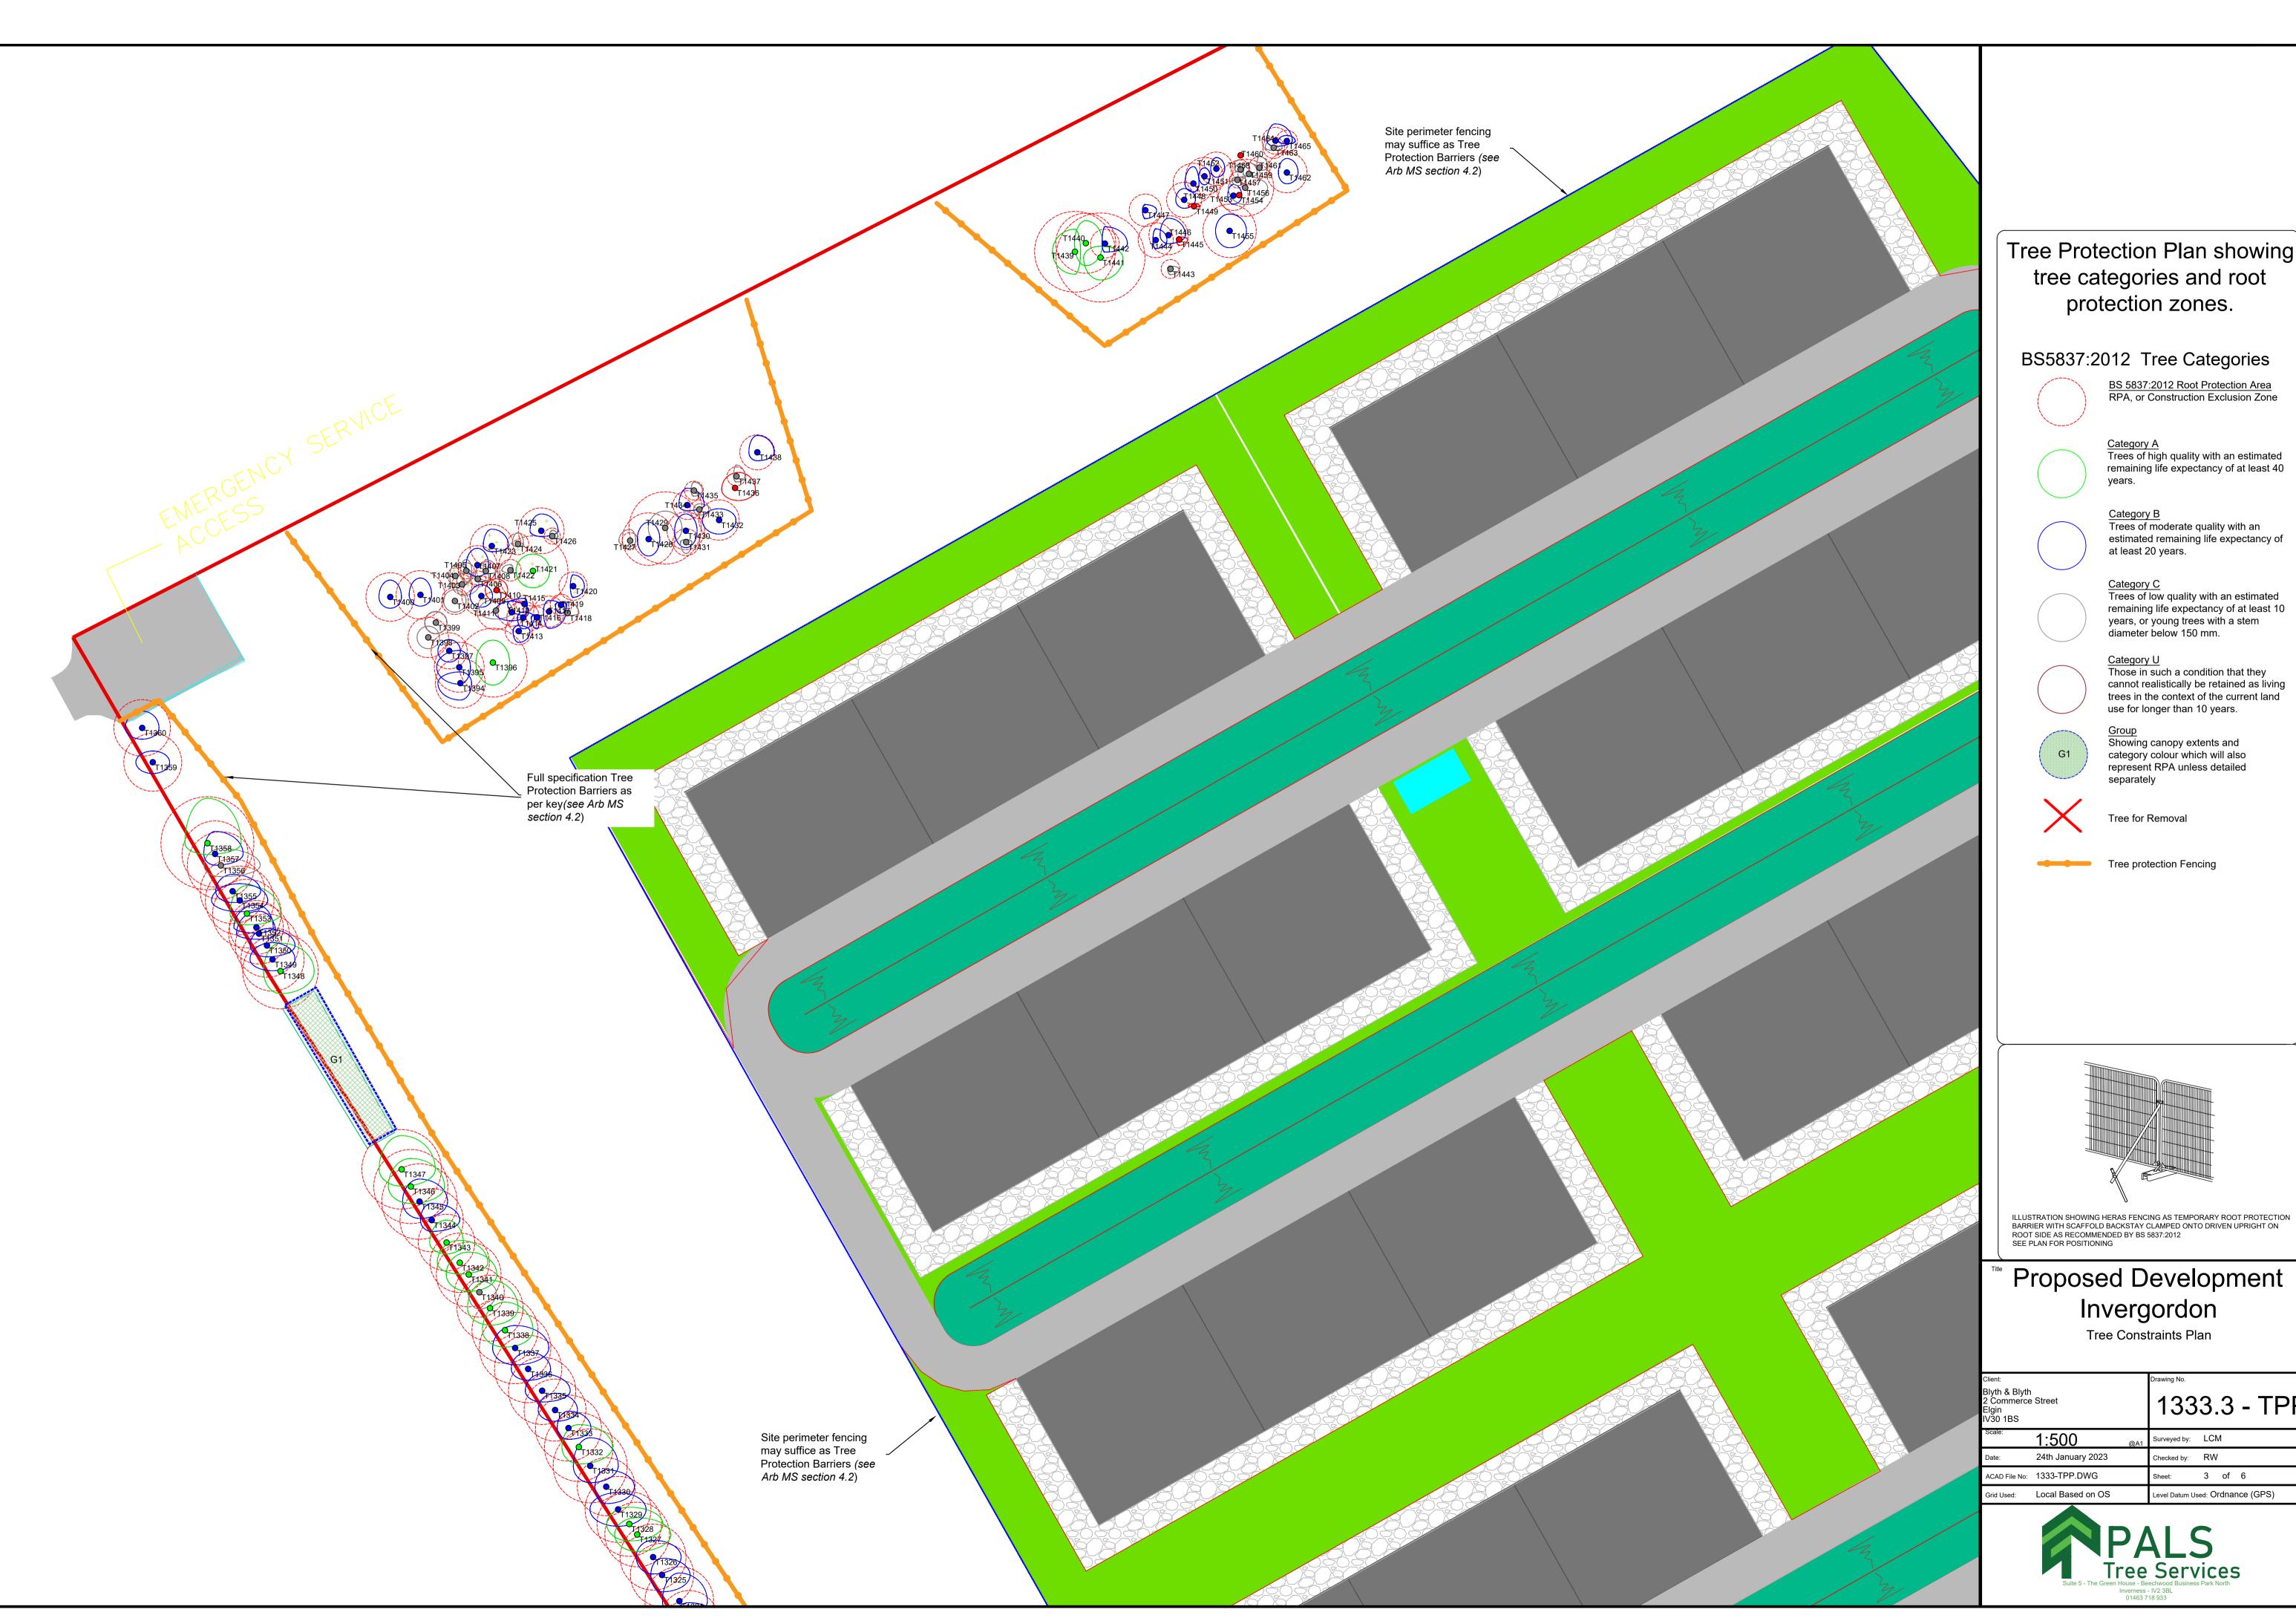

Tree Protection Plan showing tree categories and root

BS5837:2012 Tree Categories


<u>Category U</u> Those in such a condition that they cannot realistically be retained as living trees in the context of the current land


ILLUSTRATION SHOWING HERAS FENCING AS TEMPORARY ROOT PROTECTION BARRIER WITH SCAFFOLD BACKSTAY CLAMPED ONTO DRIVEN UPRIGHT ON ROOT SIDE AS RECOMMENDED BY BS 5837:2012 SEE PLAN FOR POSITIONING


| ^{Client:} Blyth & Blyth 2 Commerce Elgin IV30 1BS | | 1333.3 - TPP | | | | | | | |
|--|----------------------|----------------|--------------------|--|--|--|--|--|--|
| Scale: | 1:500 _{@A1} | Surveyed by: | LCM | | | | | | |
| Date: | 24th January 2023 | Checked by: | RW | | | | | | |
| ACAD File No: | 1333-TPP.DWG | Sheet: | 3 of 6 | | | | | | |
| Grid Used: | Local Based on OS | Level Datum Us | ed: Ordnance (GPS) | | | | | | |
| | | | | | | | | | |






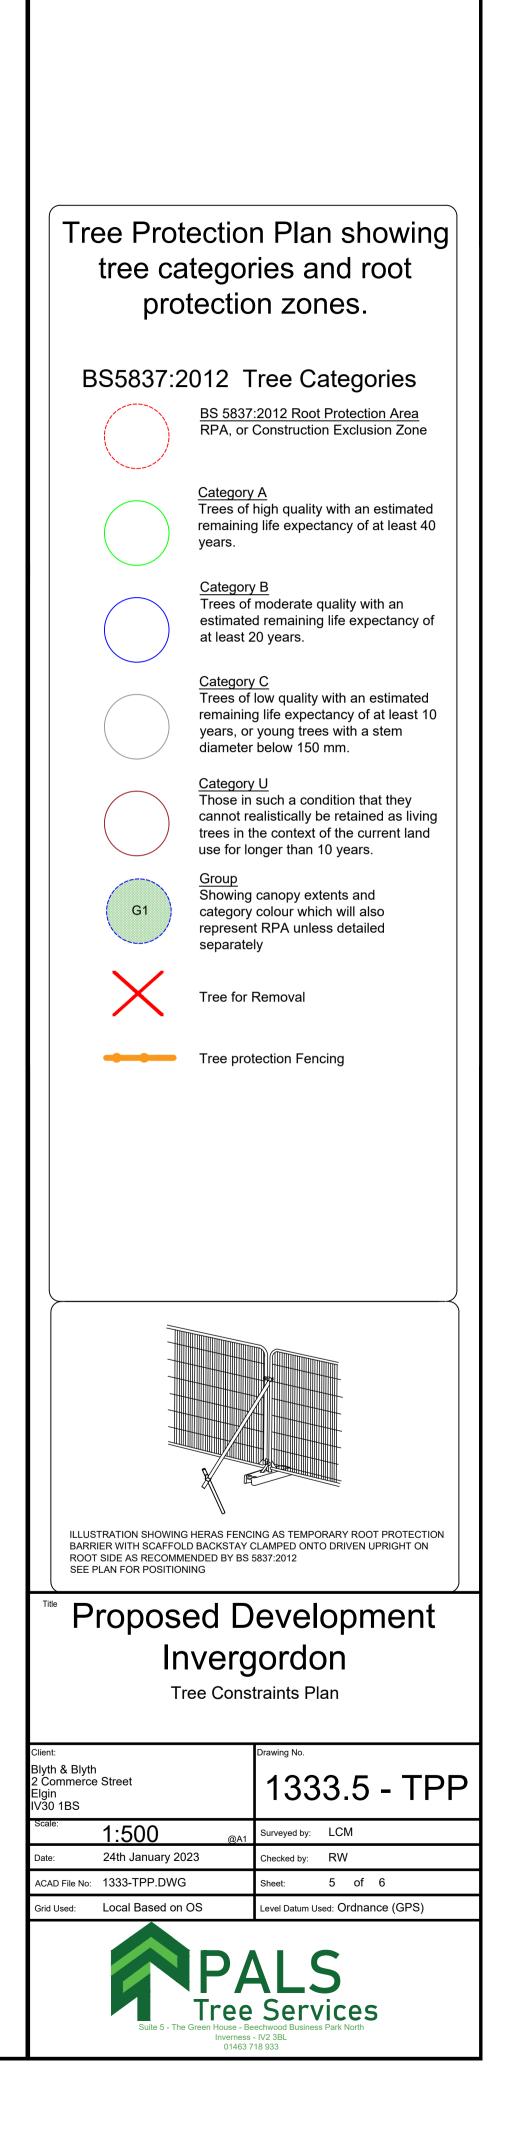


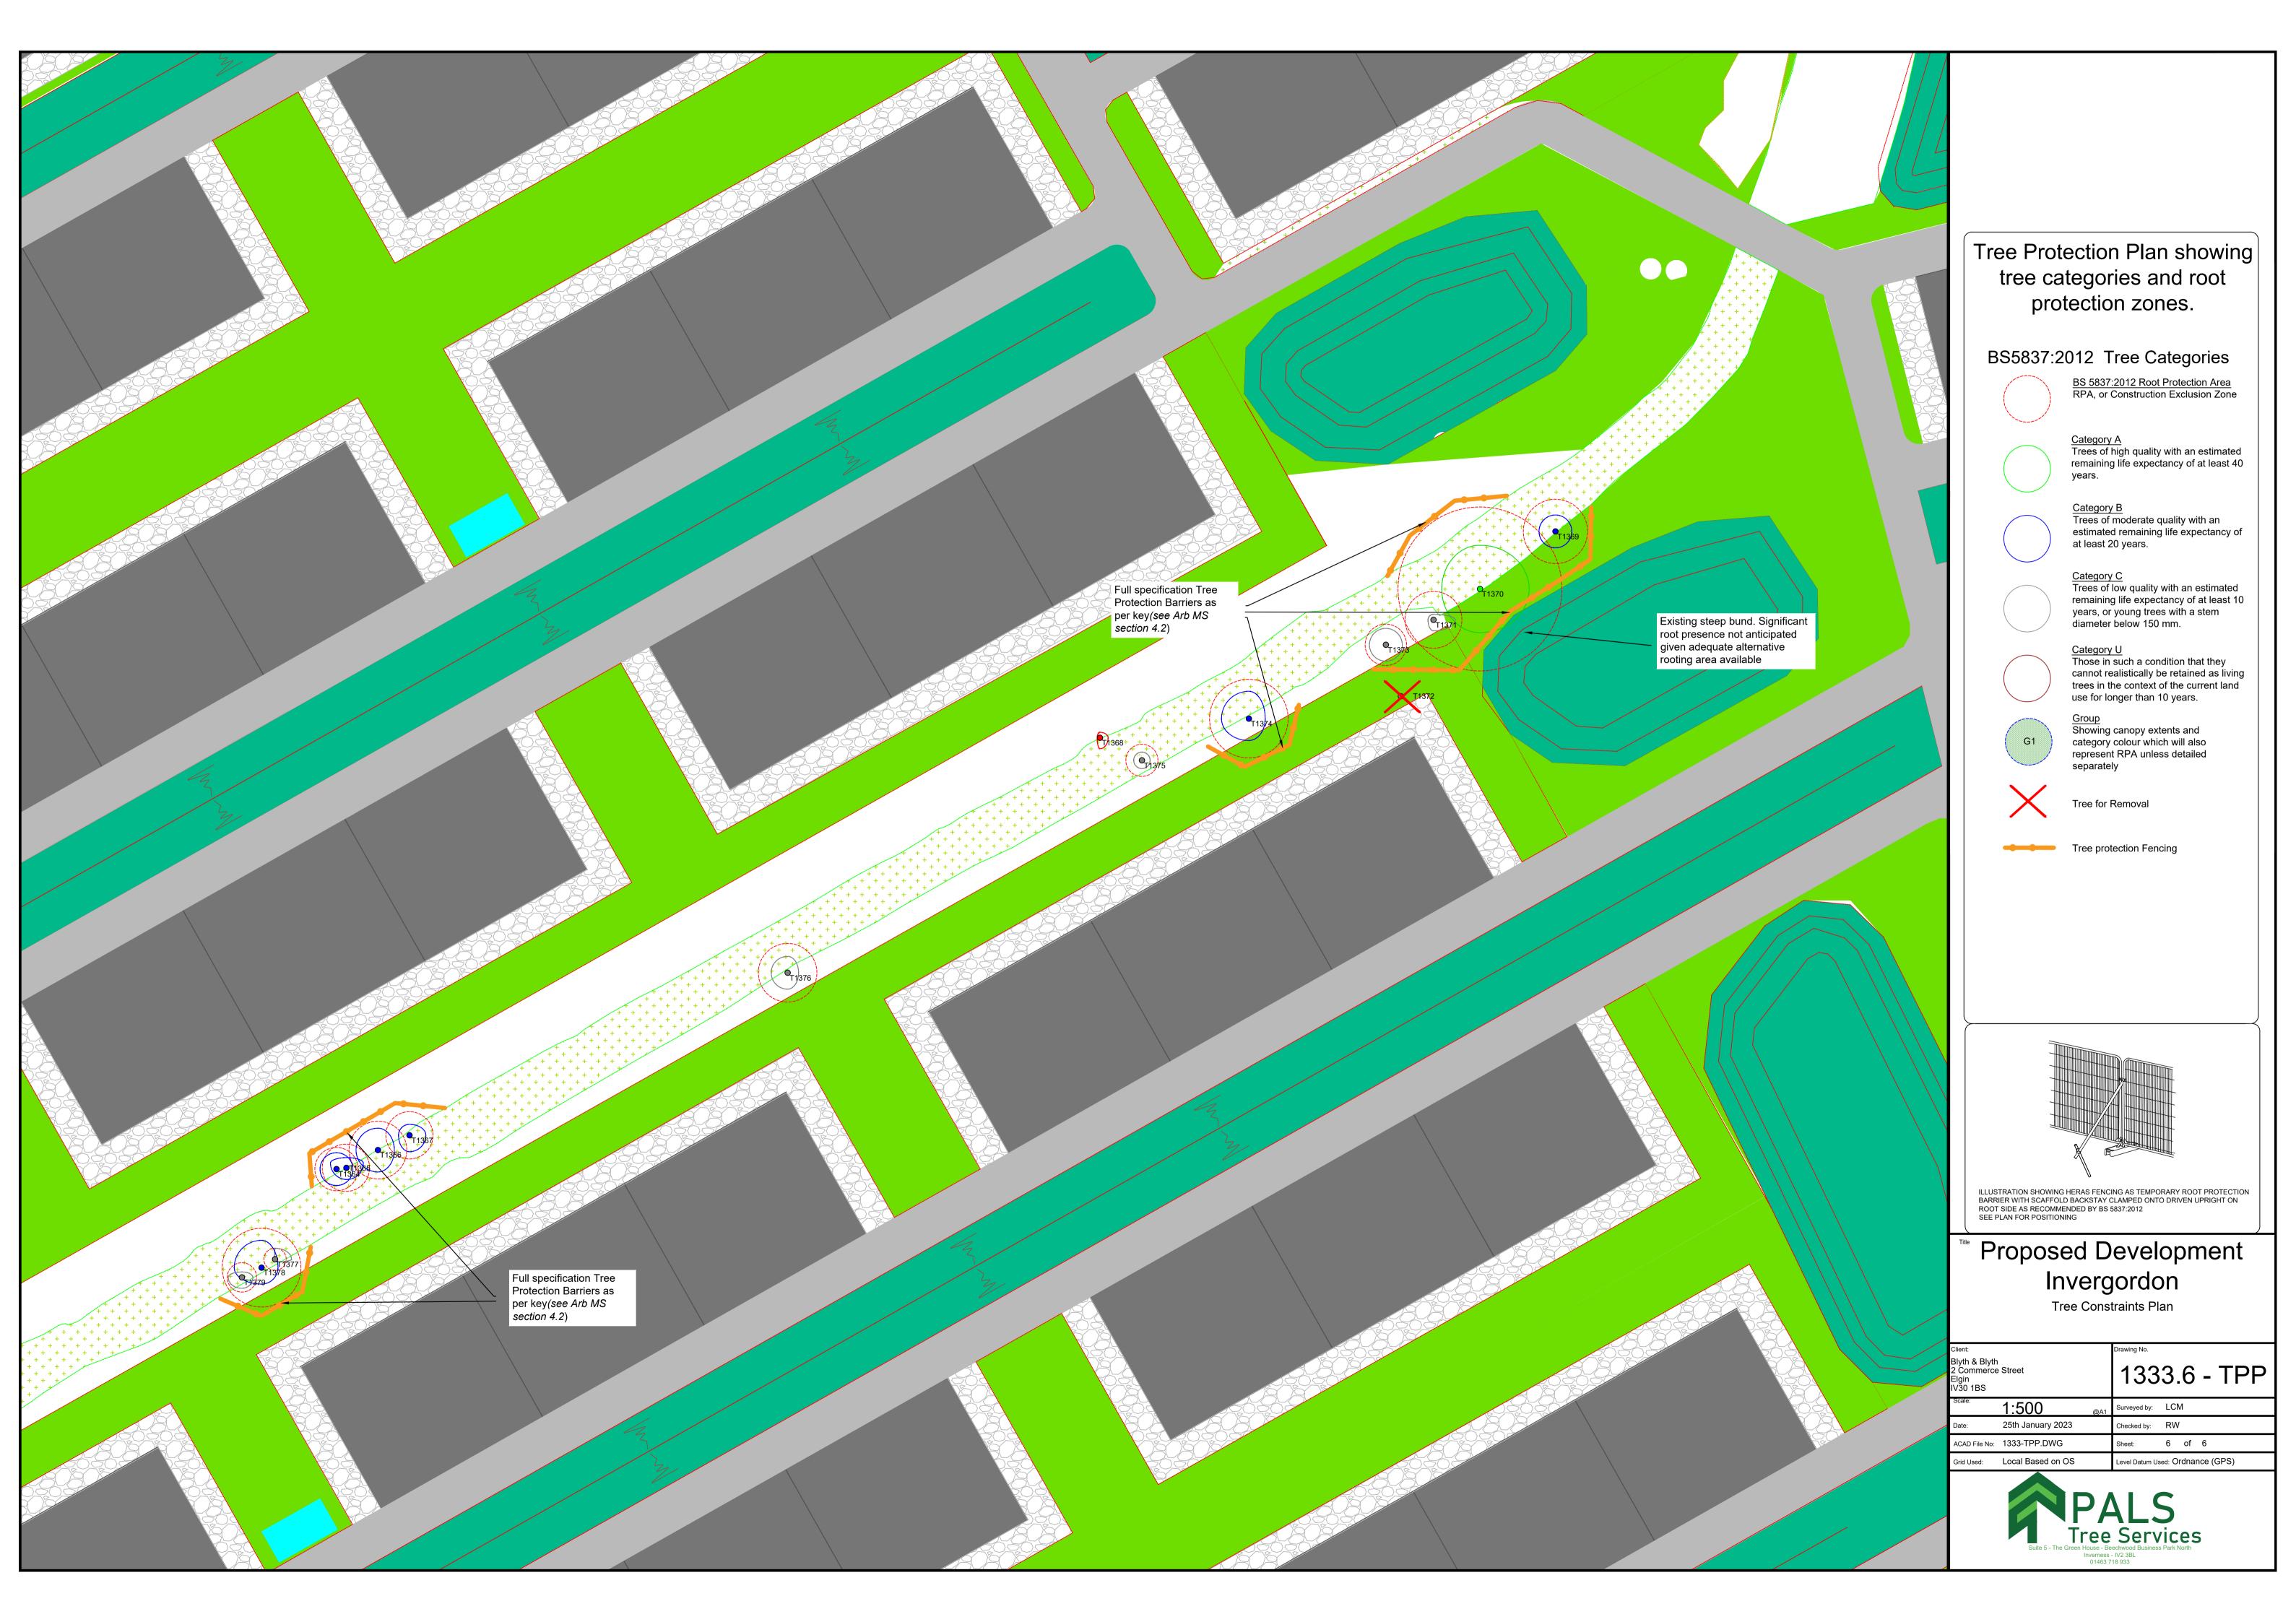

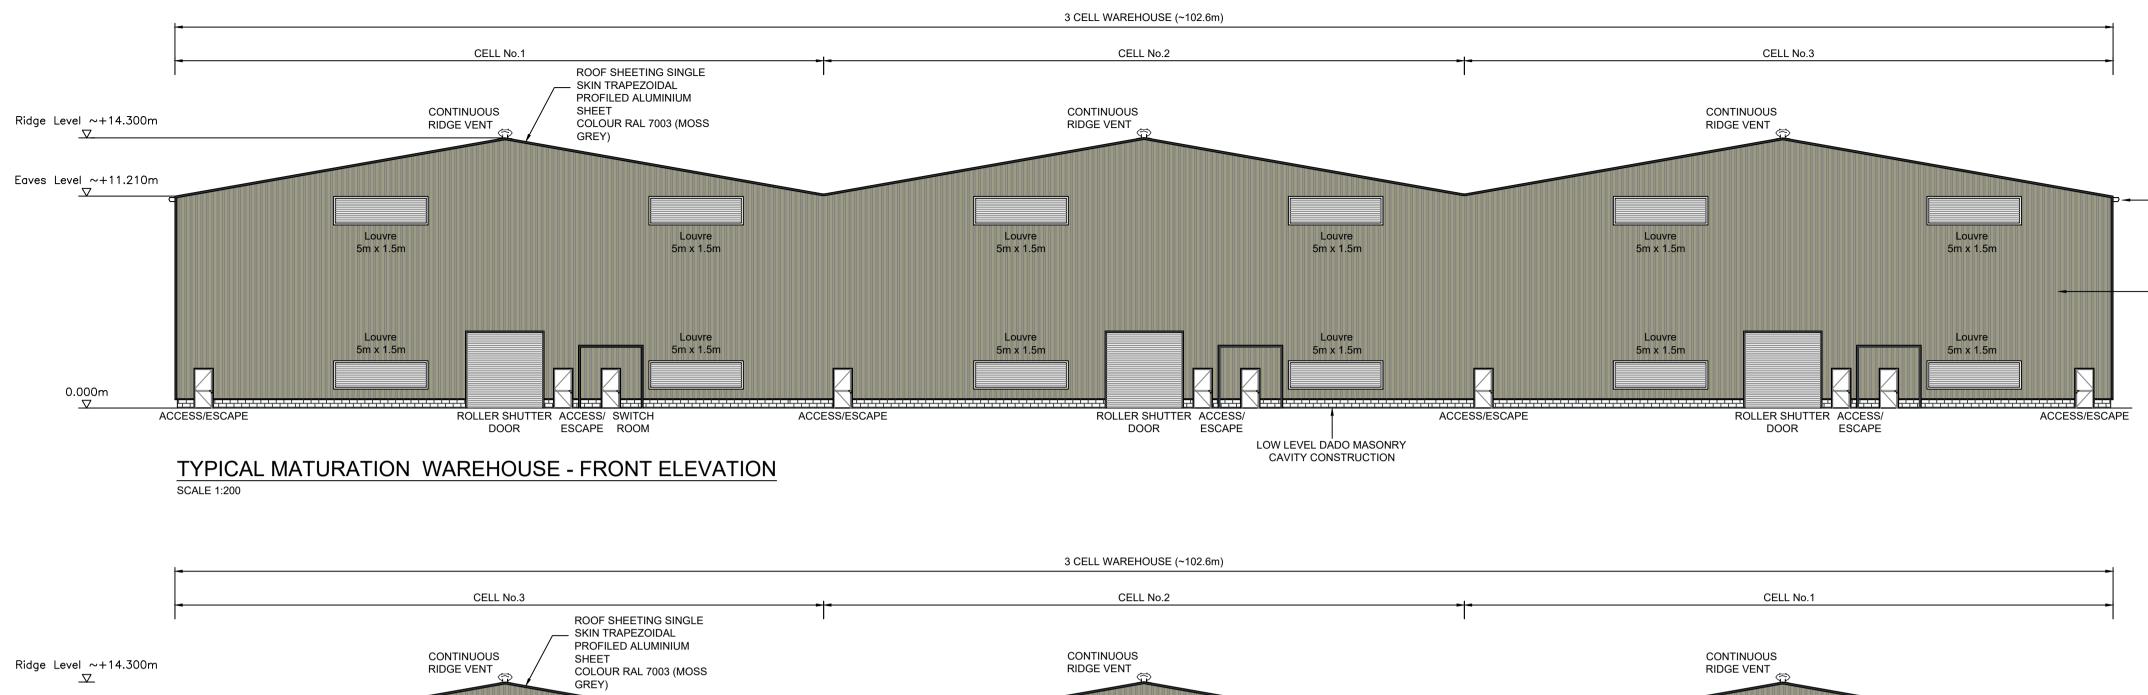

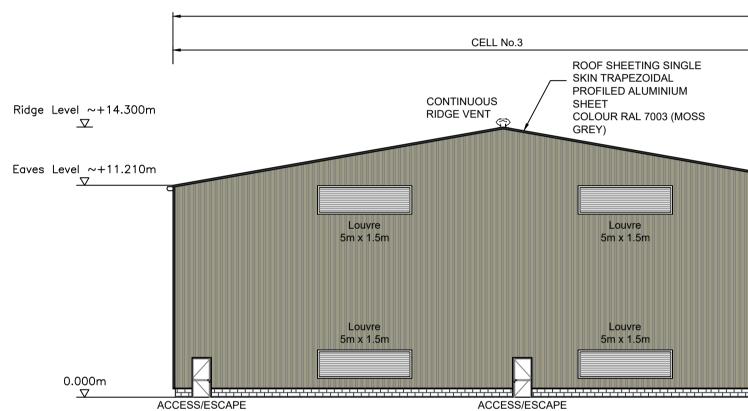


TYPICAL MATURATION WAREHOUSE - REAR ELEVATION SCALE 1:200

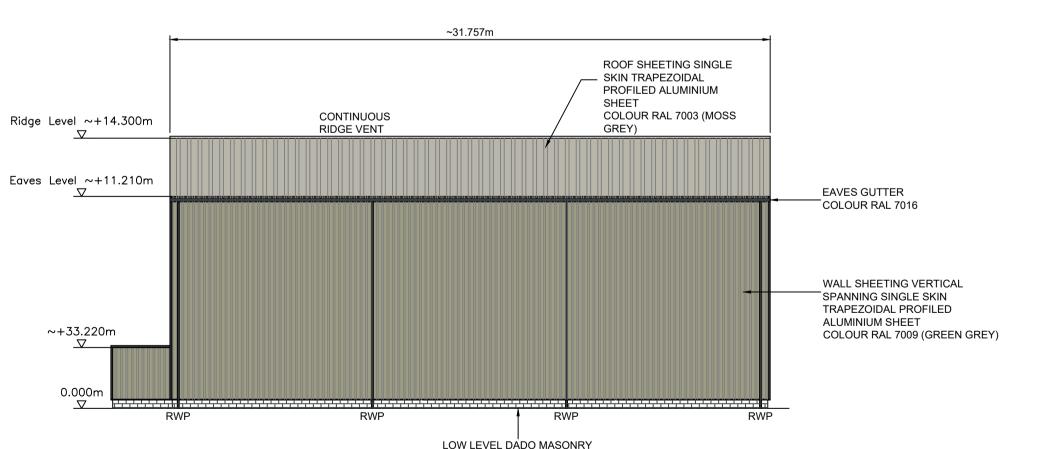

LOW LEVEL DADO MASONRY CAVITY CONSTRUCTION

TYPICAL MATURATION WAREHOUSE - GABLE ELEVATION SCALE 1:200

Notes

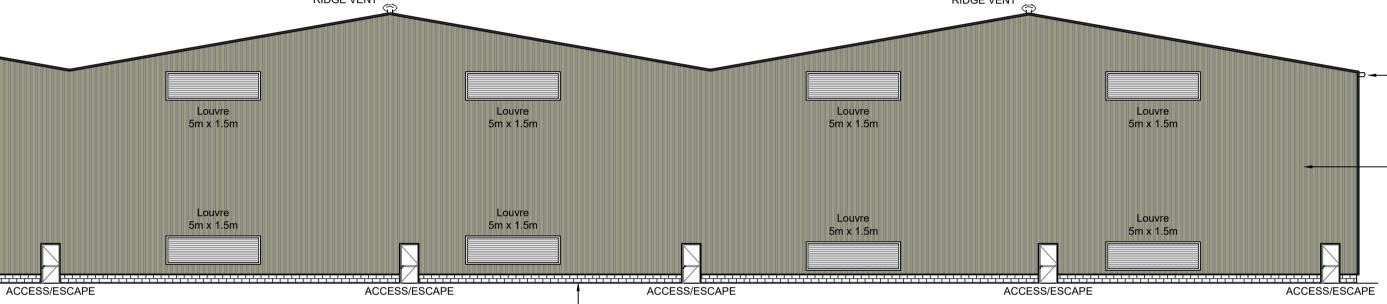

LOW LEVEL DADO MASONRY CAVITY CONSTRUCTION

| Revisions | Date | Drn. | R A | evisions RAL Colour amended. | Date 16.11.2 | rn. A | WHYTE AND MACKAY |
|-----------|------|------|--------|---------------------------------|-----------------|--------------|---------------------|
| | | | | | | | PLANNING DRAWING |

EAVES GUTTER COLOUR RAL 7016

WALL SHEETING VERTICAL SPANNING SINGLE SKIN TRAPEZOIDAL PROFILED ALUMINIUM SHEET COLOUR RAL 7009 (GREEN GREY)

EAVES GUTTER COLOUR RAL 7016

WALL SHEETING VERTICAL SPANNING SINGLE SKIN TRAPEZOIDAL PROFILED ALUMINIUM SHEET COLOUR RAL 7009 (GREEN GREY)


| BLYT | - & B | YTH |
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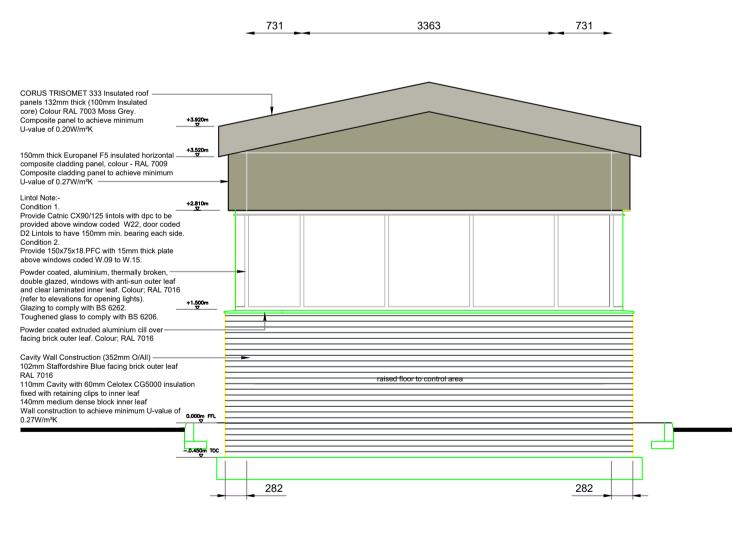
INVERGORDON MATURATION WAREHOUSING

TYPICAL WAREHOUSE ELEVATIONS

| Drawn: EMP | Ck'd _{AA} | Scale 1:200 @ A1 |
|---------------|------------------------------|------------------|
| Date: Nov '22 | Date [:] Nov '22 | DO NOT SCALE |
| | | |
| Drawing No. | | Revision |
| EC2280 | 8:00:108 | А |




NORTH ELEVATION

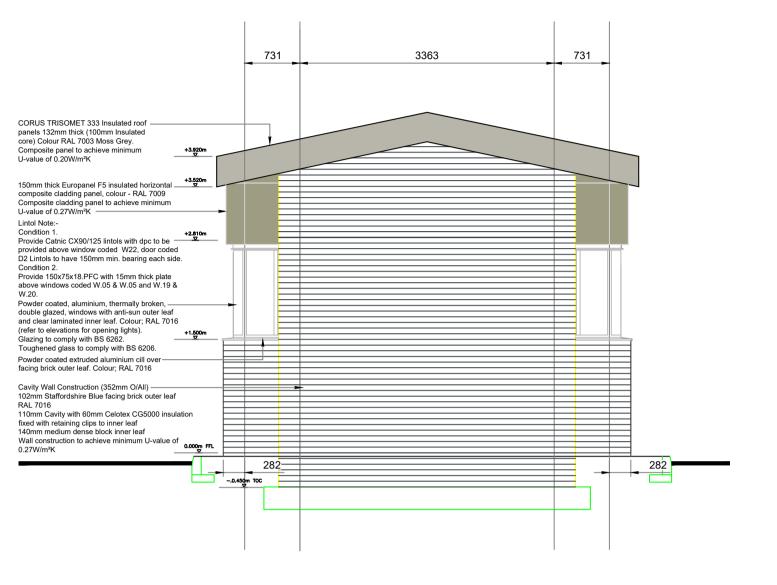



SOUTH ELEVATION

Notes

| Revisions | Date | Drn. | F A | RAL Colour amended. | Date 16.11.22 | Drn. AA | WHYTE AND MACKAY |
|-----------|------|------|--------|---------------------|------------------|------------|---------------------|
| | | | | | | | PLANNING DRAWING |

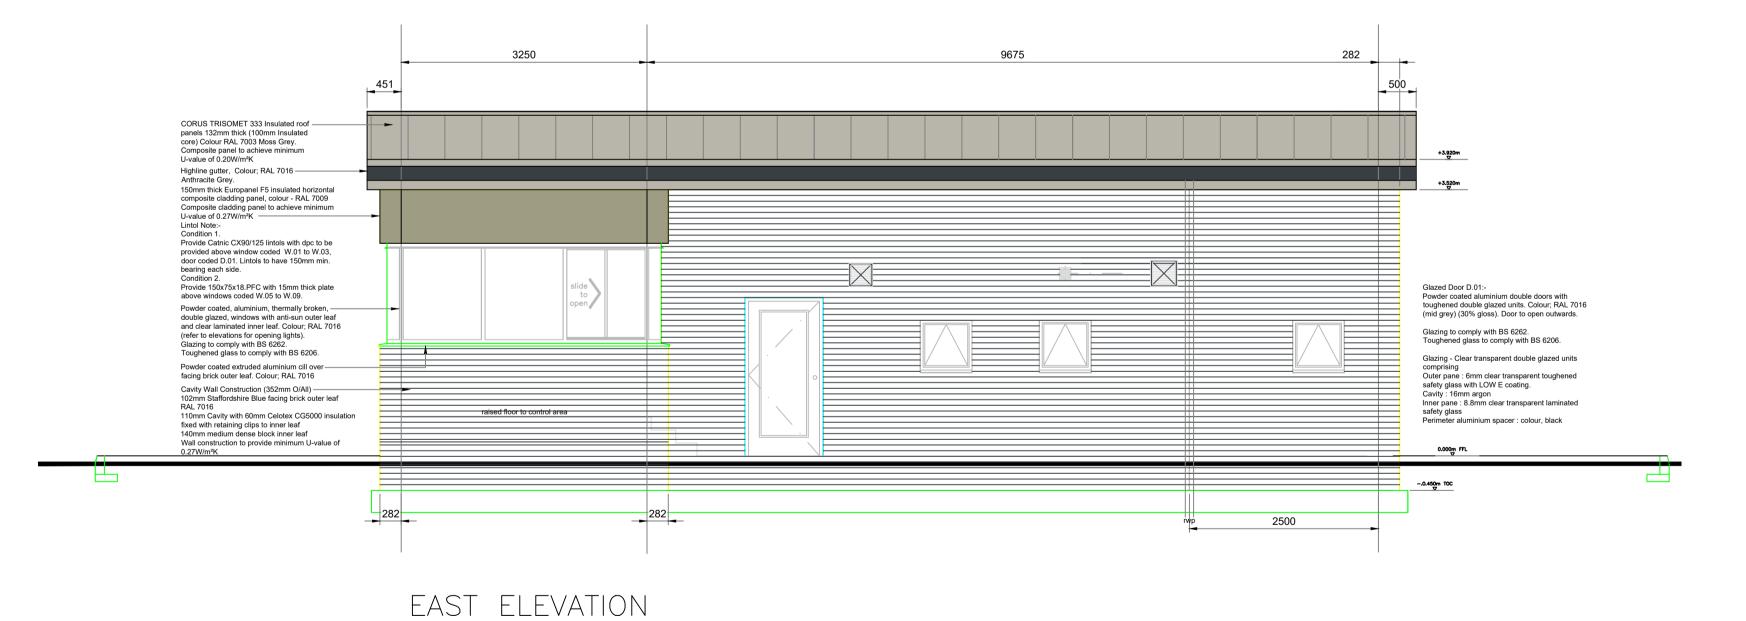

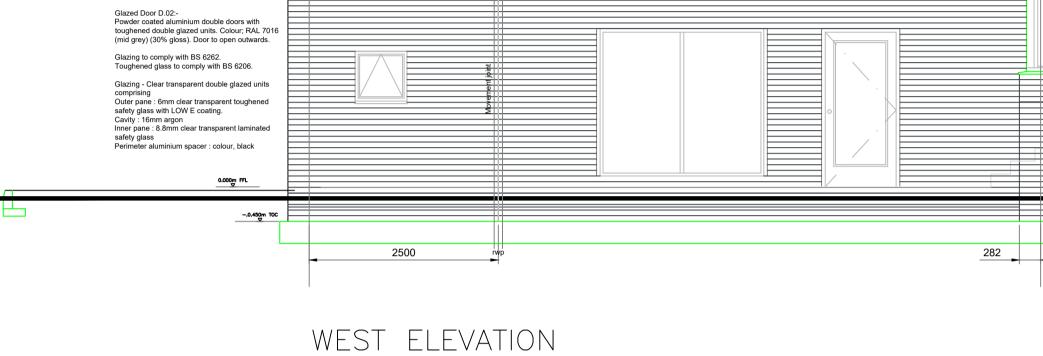

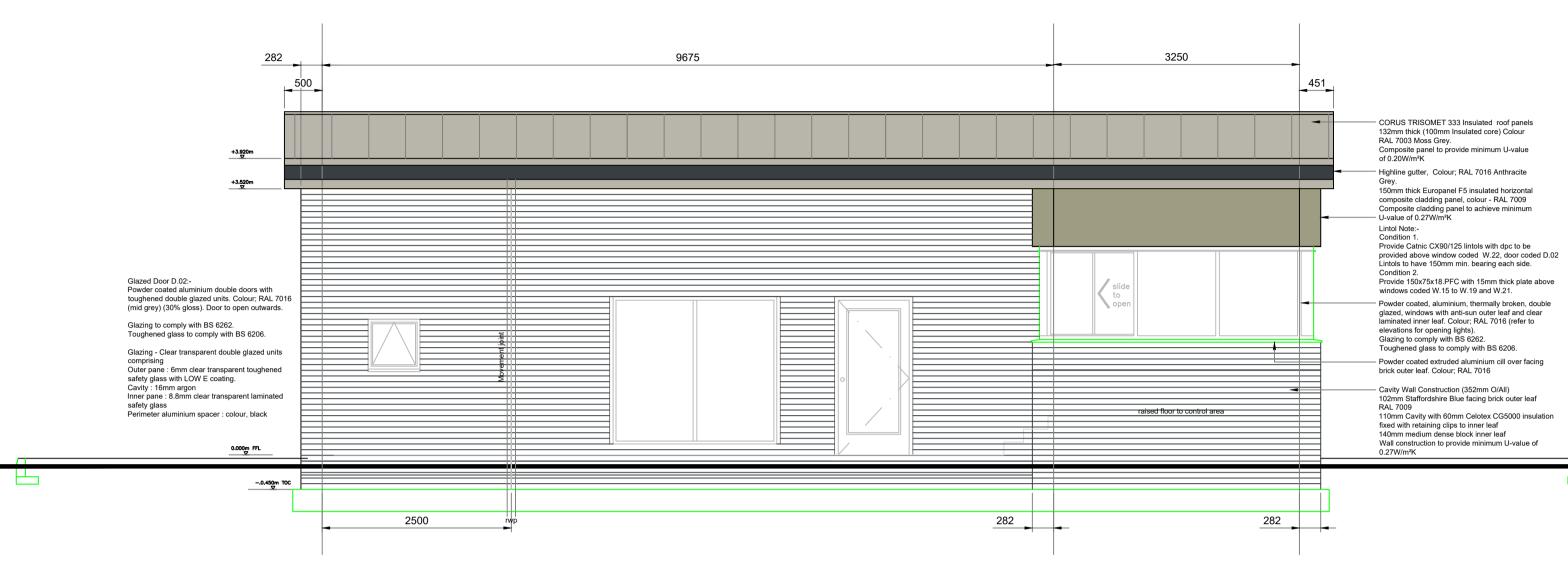


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|-------------------------------------|
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| Edinburgh EH12 9EB |

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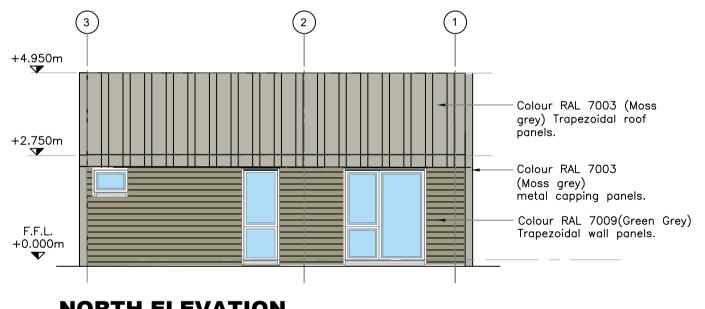
INVERGORDON MATURATION WAREHOUSING GATEHOUSE ELEVATIONS

| Drawn: EMP | Ck'd _{AA} | Scale 1:50 @ A1 |
|---------------|--------------------|-----------------|
| Date: Nov '22 | Date: | DO NOT SCALE |
| | | |
| Drawing No. | | Revision |
| EC2280 | 8:00:117 | А |

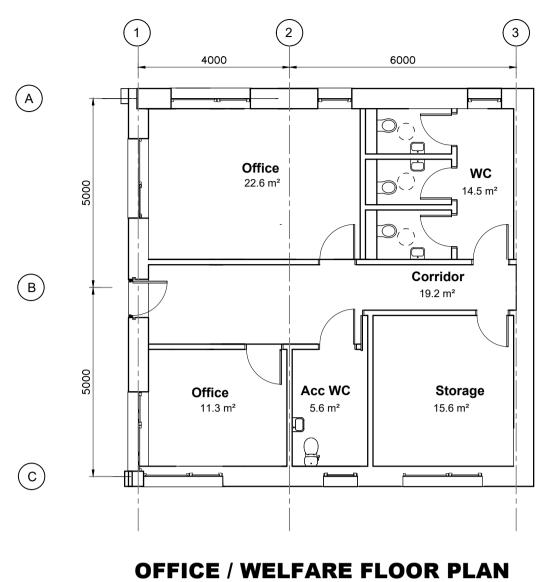


SCALE 1:100


₩₩ | | | | | | | | | | 1:100@A1 0 ¹ ² ³ ⁴ 5m 10m




NORTH ELEVATION SCALE 1:100

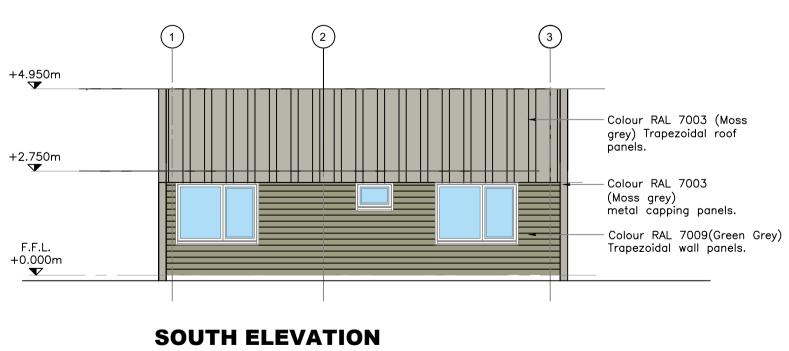


SCALE 1:100

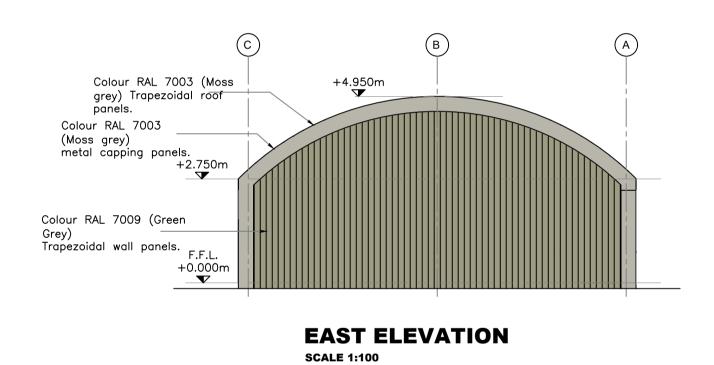

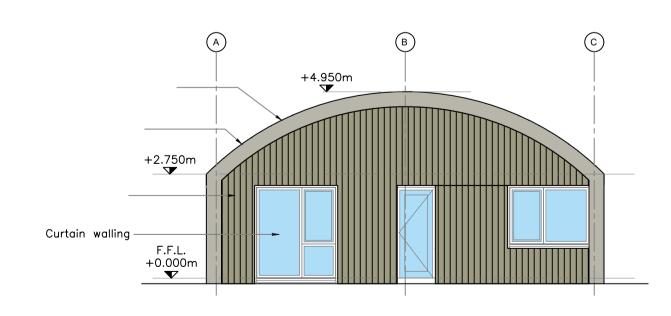

WEST ELEVATION SCALE 1:100

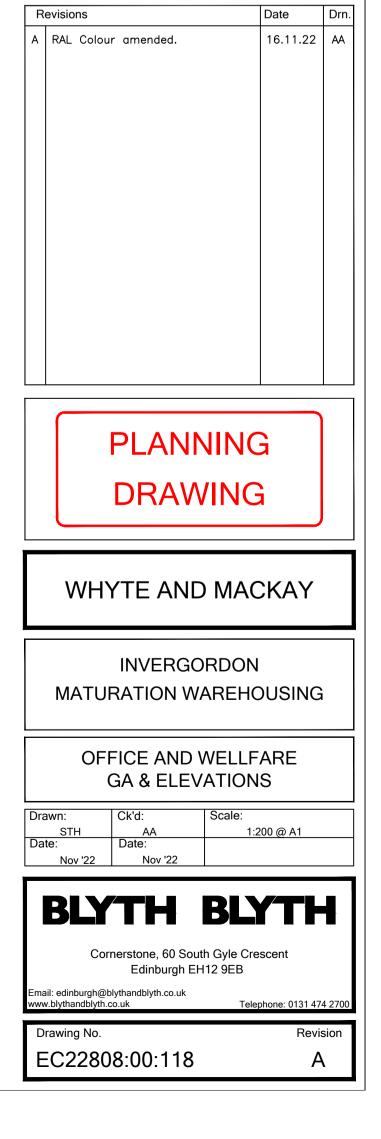


Doors Specification

- External secuirity metal door to be Martin Roberts or
- Finish to be polyester powder coated to BS 6496. Colour to be RAL 7016
- Colour to be RAL 7016 (grey).
 Door size to fit structural opening
 HAandles: (based on Guardian Omnidor-select, of NT separal LOWLAND ENSOR LTD.)"STEDEN" 19ø round bar 57, in Aluminium with compatible accessories
- with compatible accessories. Lock: type LK01: (based on Allgood hardware) Cat. No. 7279: Vertical Euro profile
- cylinder mortice lock. Case size to suit door make-up. Finish in satin stainless steel (SS) use Modric 755 rose, with 9501 distance piece. Glass above: Fixed 4mm th. clear glass to form fan-light. Glass set in bed of putty and secured with tapered timber beads.

Notes

4.25 – attic 4.25 – atti _____ ╵┝╴╘┑┶┑┶┑┷╷┷╷┷╷┵┍┽┯┥┯┥┯╎┯╵┯╵┯╘┯╘┑┶┑┷╷┷╷┷┍┷╷ ╤┝╤┝╤┶╤┶╤┶╤┿╤┿╤┽╤┥╤╛╤╛╤╝╤╵╤┝╤┶╤┶╤┶╤┷╤╇╶┿╶┿╶┿ 300mm thk. Cavity wall: 100mm Facing Brick – TYRONE Dunmore with black mortar joints RAL 7016 (grey) 100mm Cavity 100mm Common medium density 7N Blockwork 0.000 – GFL ____ 0.000 - 00.0 ╞╧╹╤╤┝╤╴┶╤╴┿╕╶┷╻╼╴╼ ╶╤╵╤╵╤╵╤╵╤╶╧╡─ ,

> Electrical Sprinkler Pumphouse Front Elevation Scale 1:50

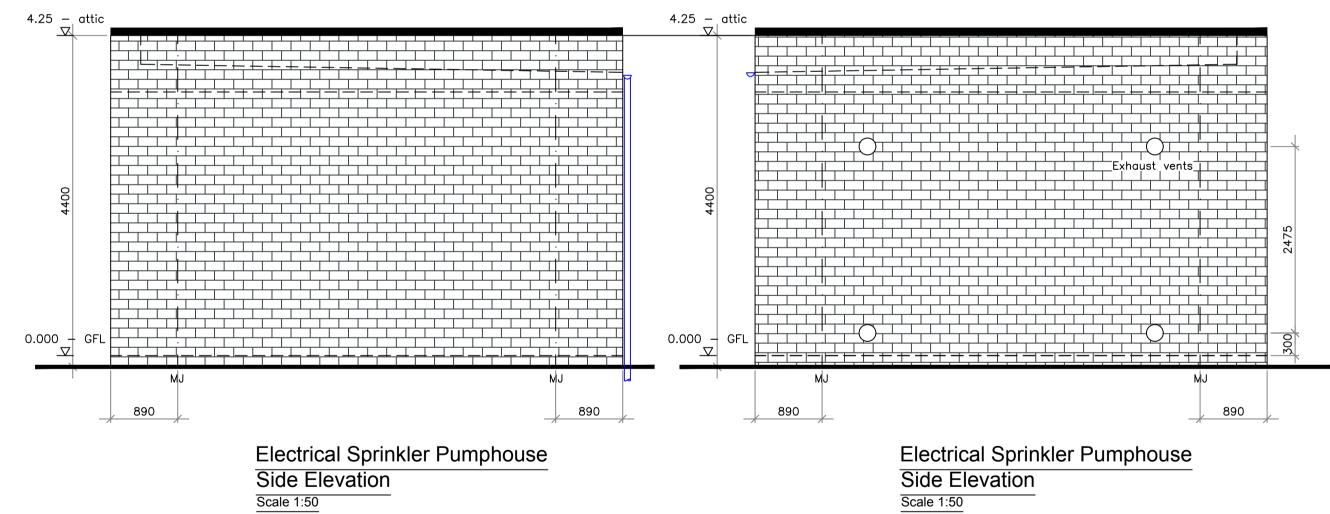





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Electrical Sprinkler Pumphouse Back Elevation Scale 1:50

Side Elevation

| Revisions | Date | Drn. | Revisions | Date | Drn. | |
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| | | | | | | WHYTE AND MACKAY |
| | | | | | | PLANNING |
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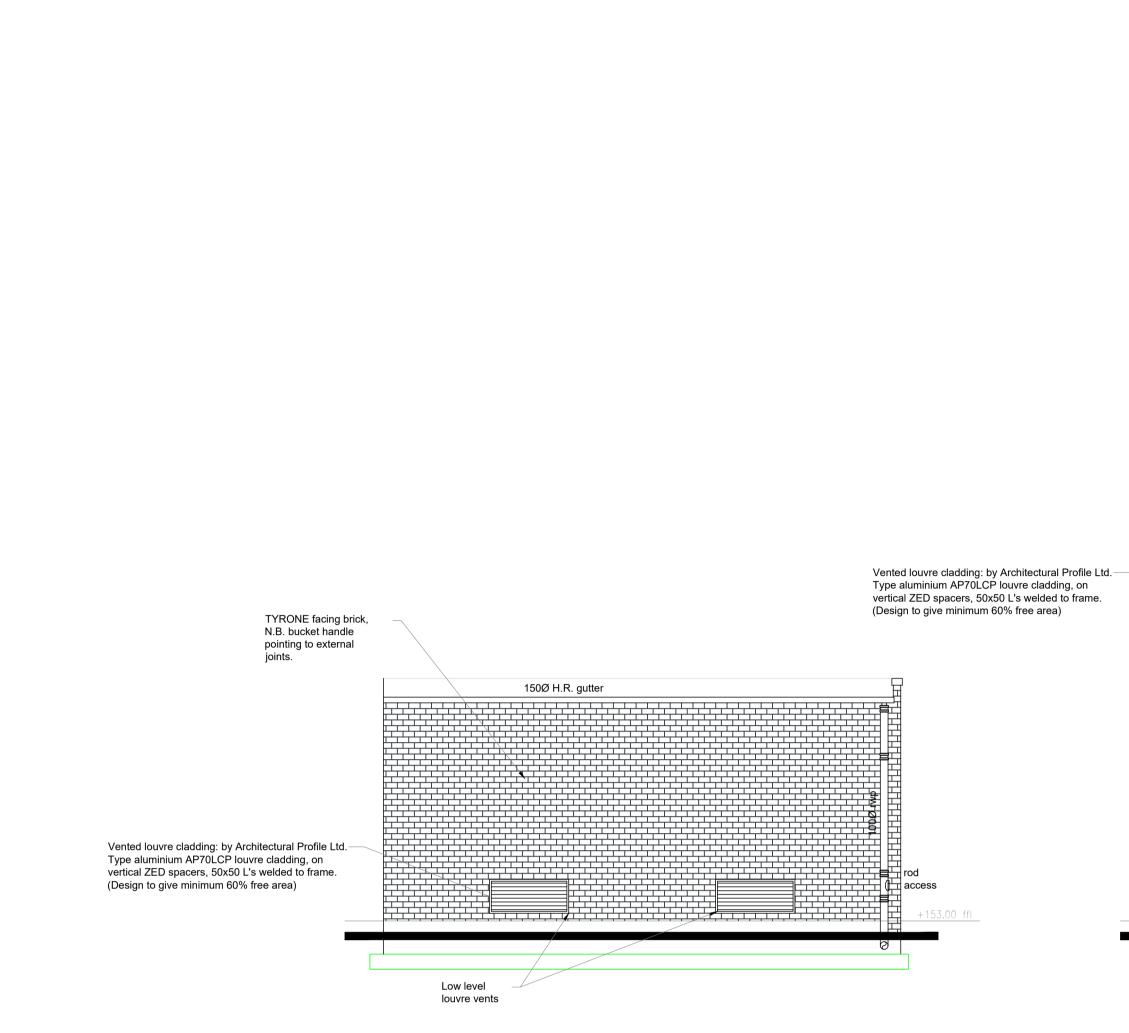
| BLYTH&BLYTH | |
|-------------------------------------|--|
| Cornerstone, 60 South Gyle Crescent | |
| Edinburgh EH12 9EB | |


| Email: edinburgh@blythandblyth.co.uk www.blythandblyth.co.uk | Telephone: 0131 474 2700 |
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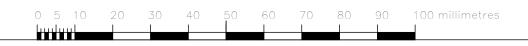
INVERGORDON MATURATION WAREHOUSING


| ELEVATIONS | | | | | | | | | | | | | | |
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| Drawn: EMP | Ck'd _{AA} | Scale AS SHOWN @ A1 | | | | | | | | | | | | |
| Date: Nov '22 | Date: Nov '22 | DO NOT SCALE | | | | | | | | | | | | |
| | | | | | | | | | | | | | | |
| Drawing No. | | Revision | | | | | | | | | | | | |
| EC2280 | 8:00:112 | - | | | | | | | | | | | | |

PUMPHOUSE







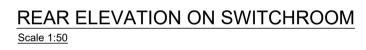

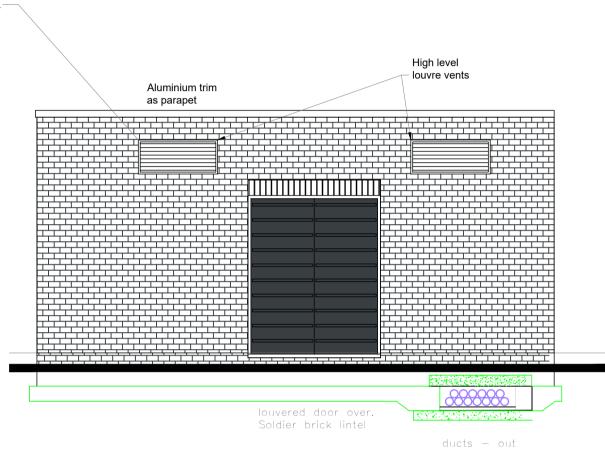

FRONT ELEVATION ON SWITCHROOM <u>Scale 1:50</u>

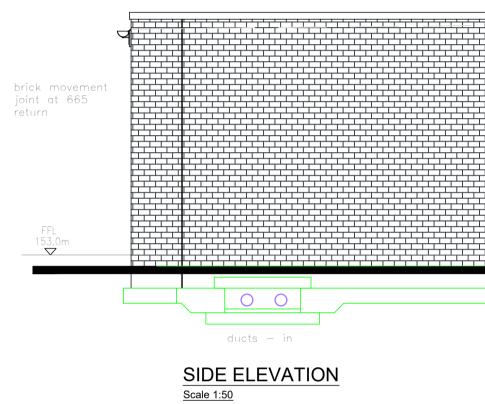

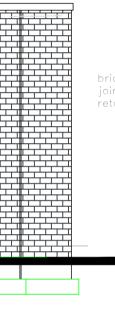


brick movement joint at 665 return


| PLANNING | |
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| WHYTE AND MACKAY | |
| INVERGORDON MATURATION WAREHOUSING | G |
| SWITCHROOM ELEVATIONS | |
| Drawn: Ck'd: Scale: EMP AA 1:50 @ A1 Date: Date: DO NOT SCAL | E |
| BLYTH&BLYTI | |
| Cornerstone, 60 South Gyle Crescent Edinburgh EH12 9EB | |
| Email: edinburgh@blythandblyth.co.uk www.blythandblyth.co.uk Telephone: 0131 4 | 474 2700 |
| Drawing No. Ret EC22808:00:116 - | vision |

Drn.

Date

Revisions

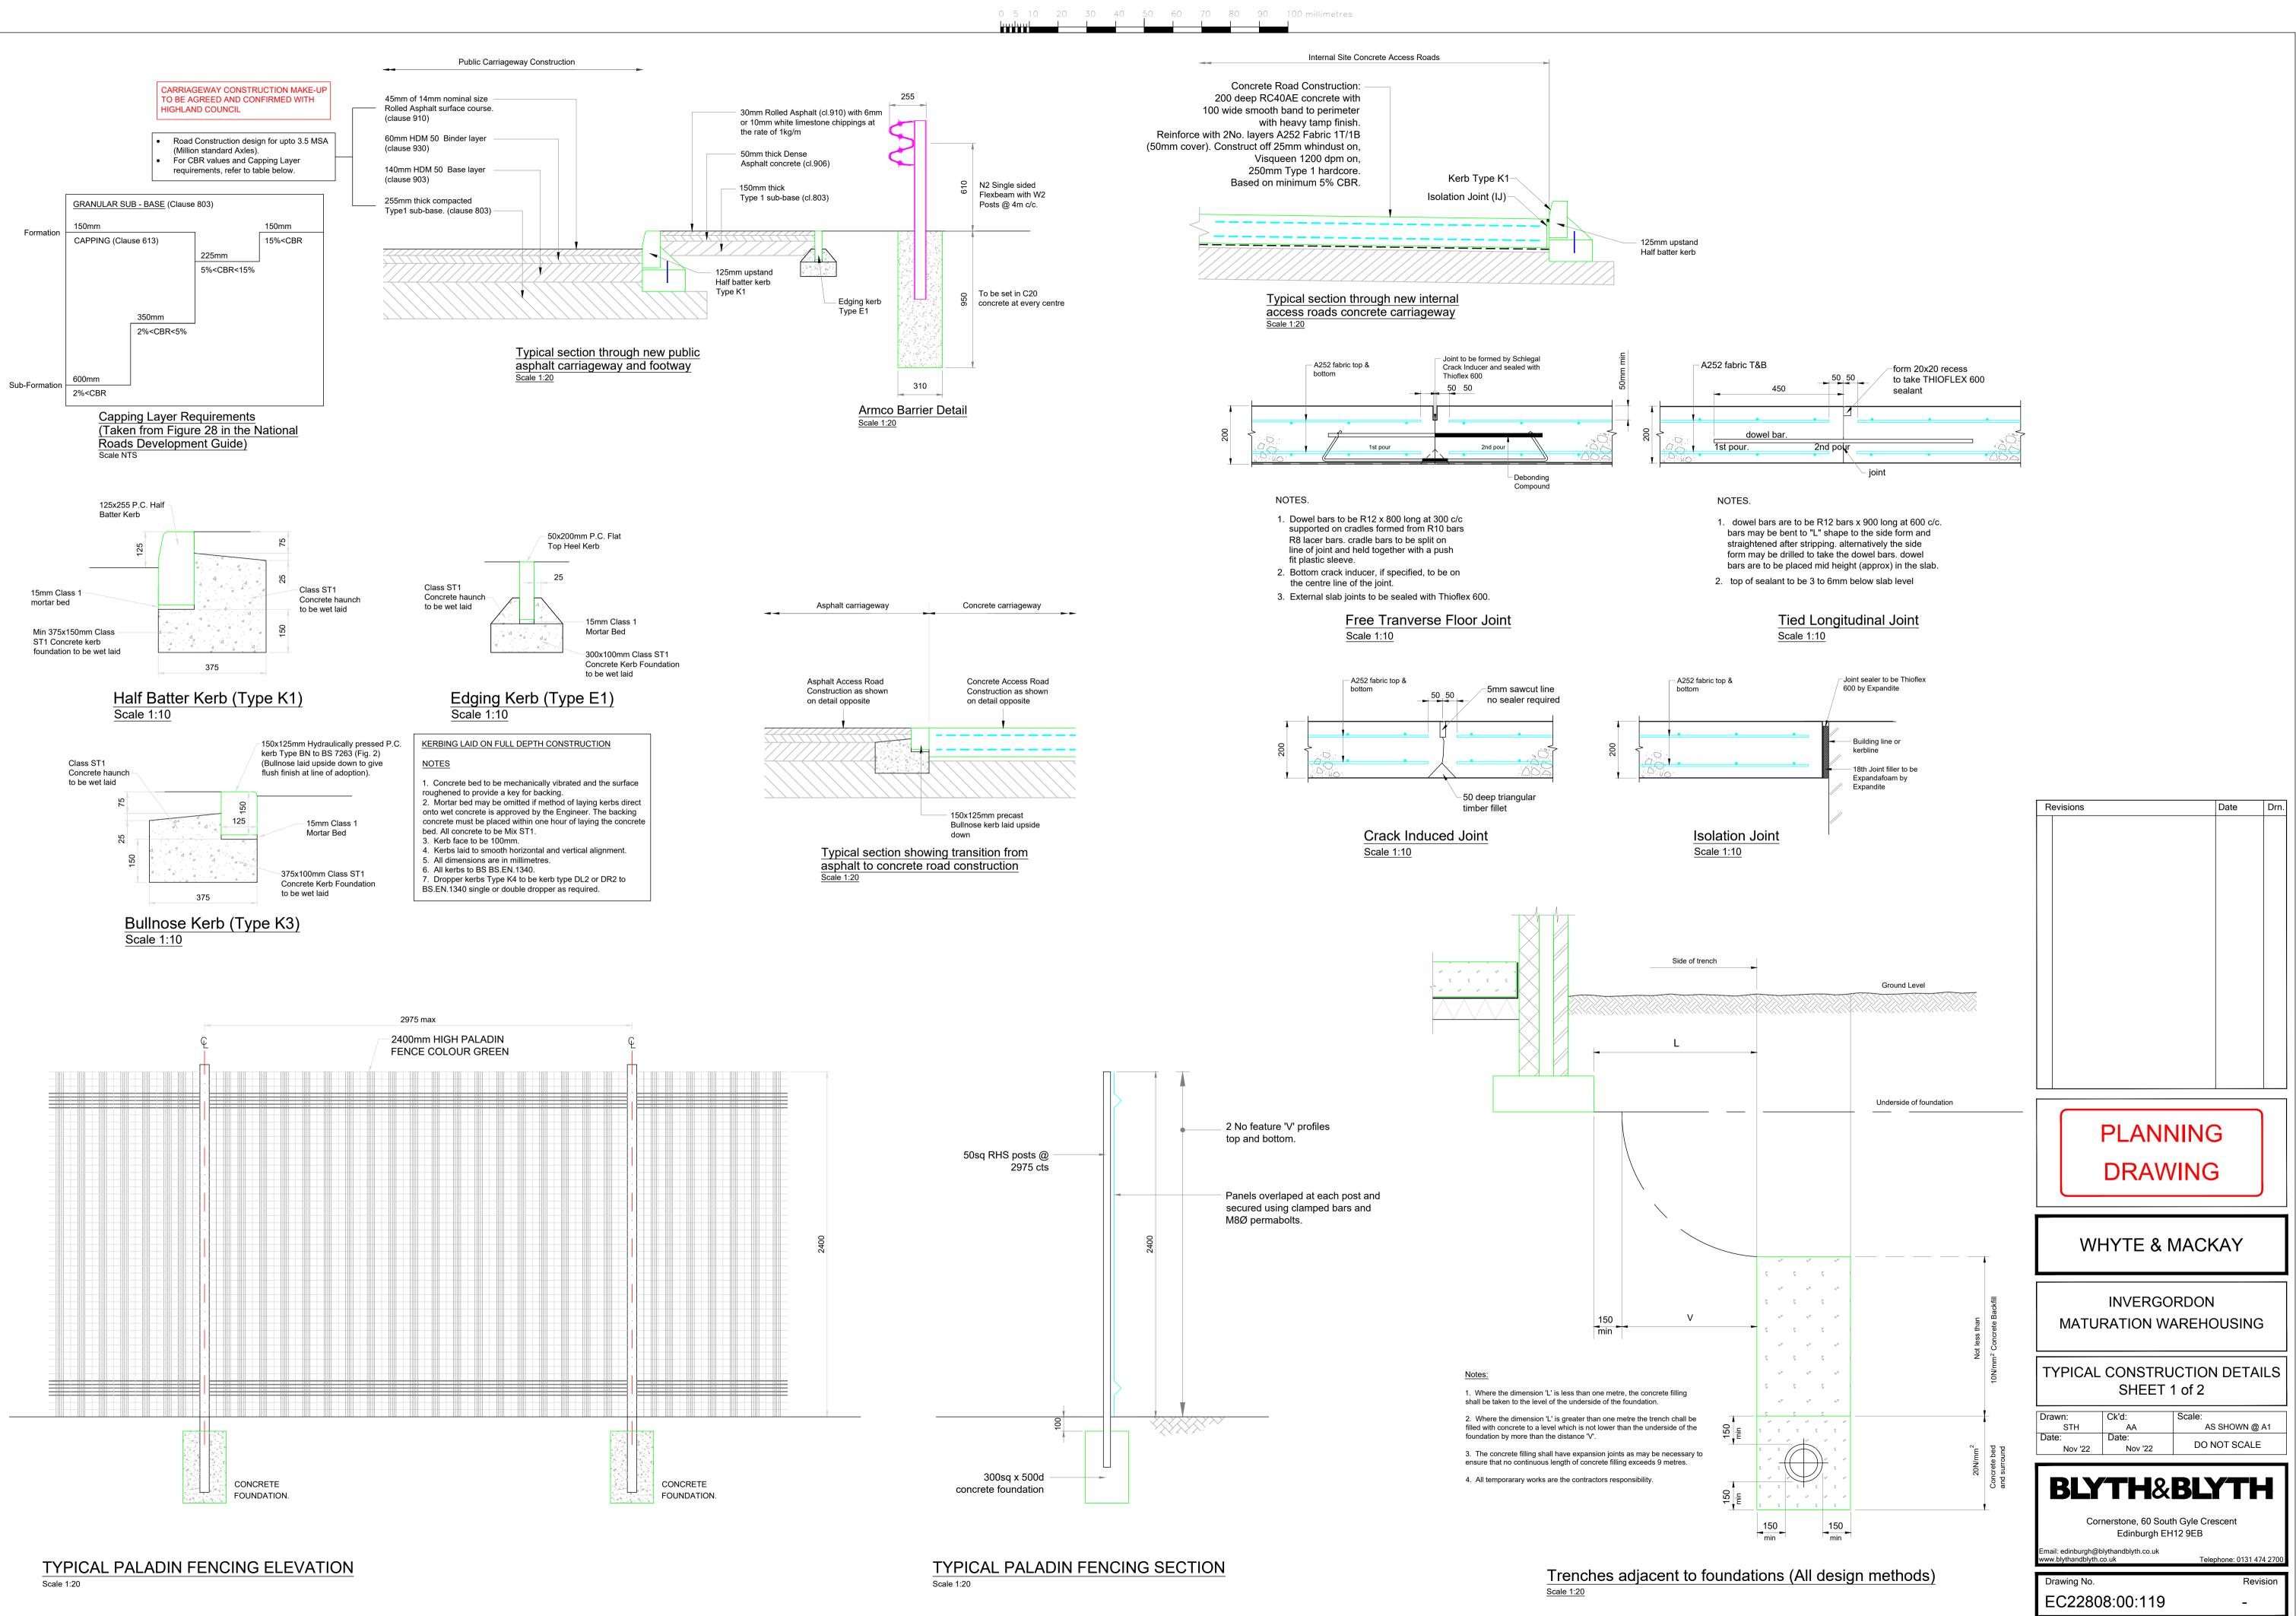

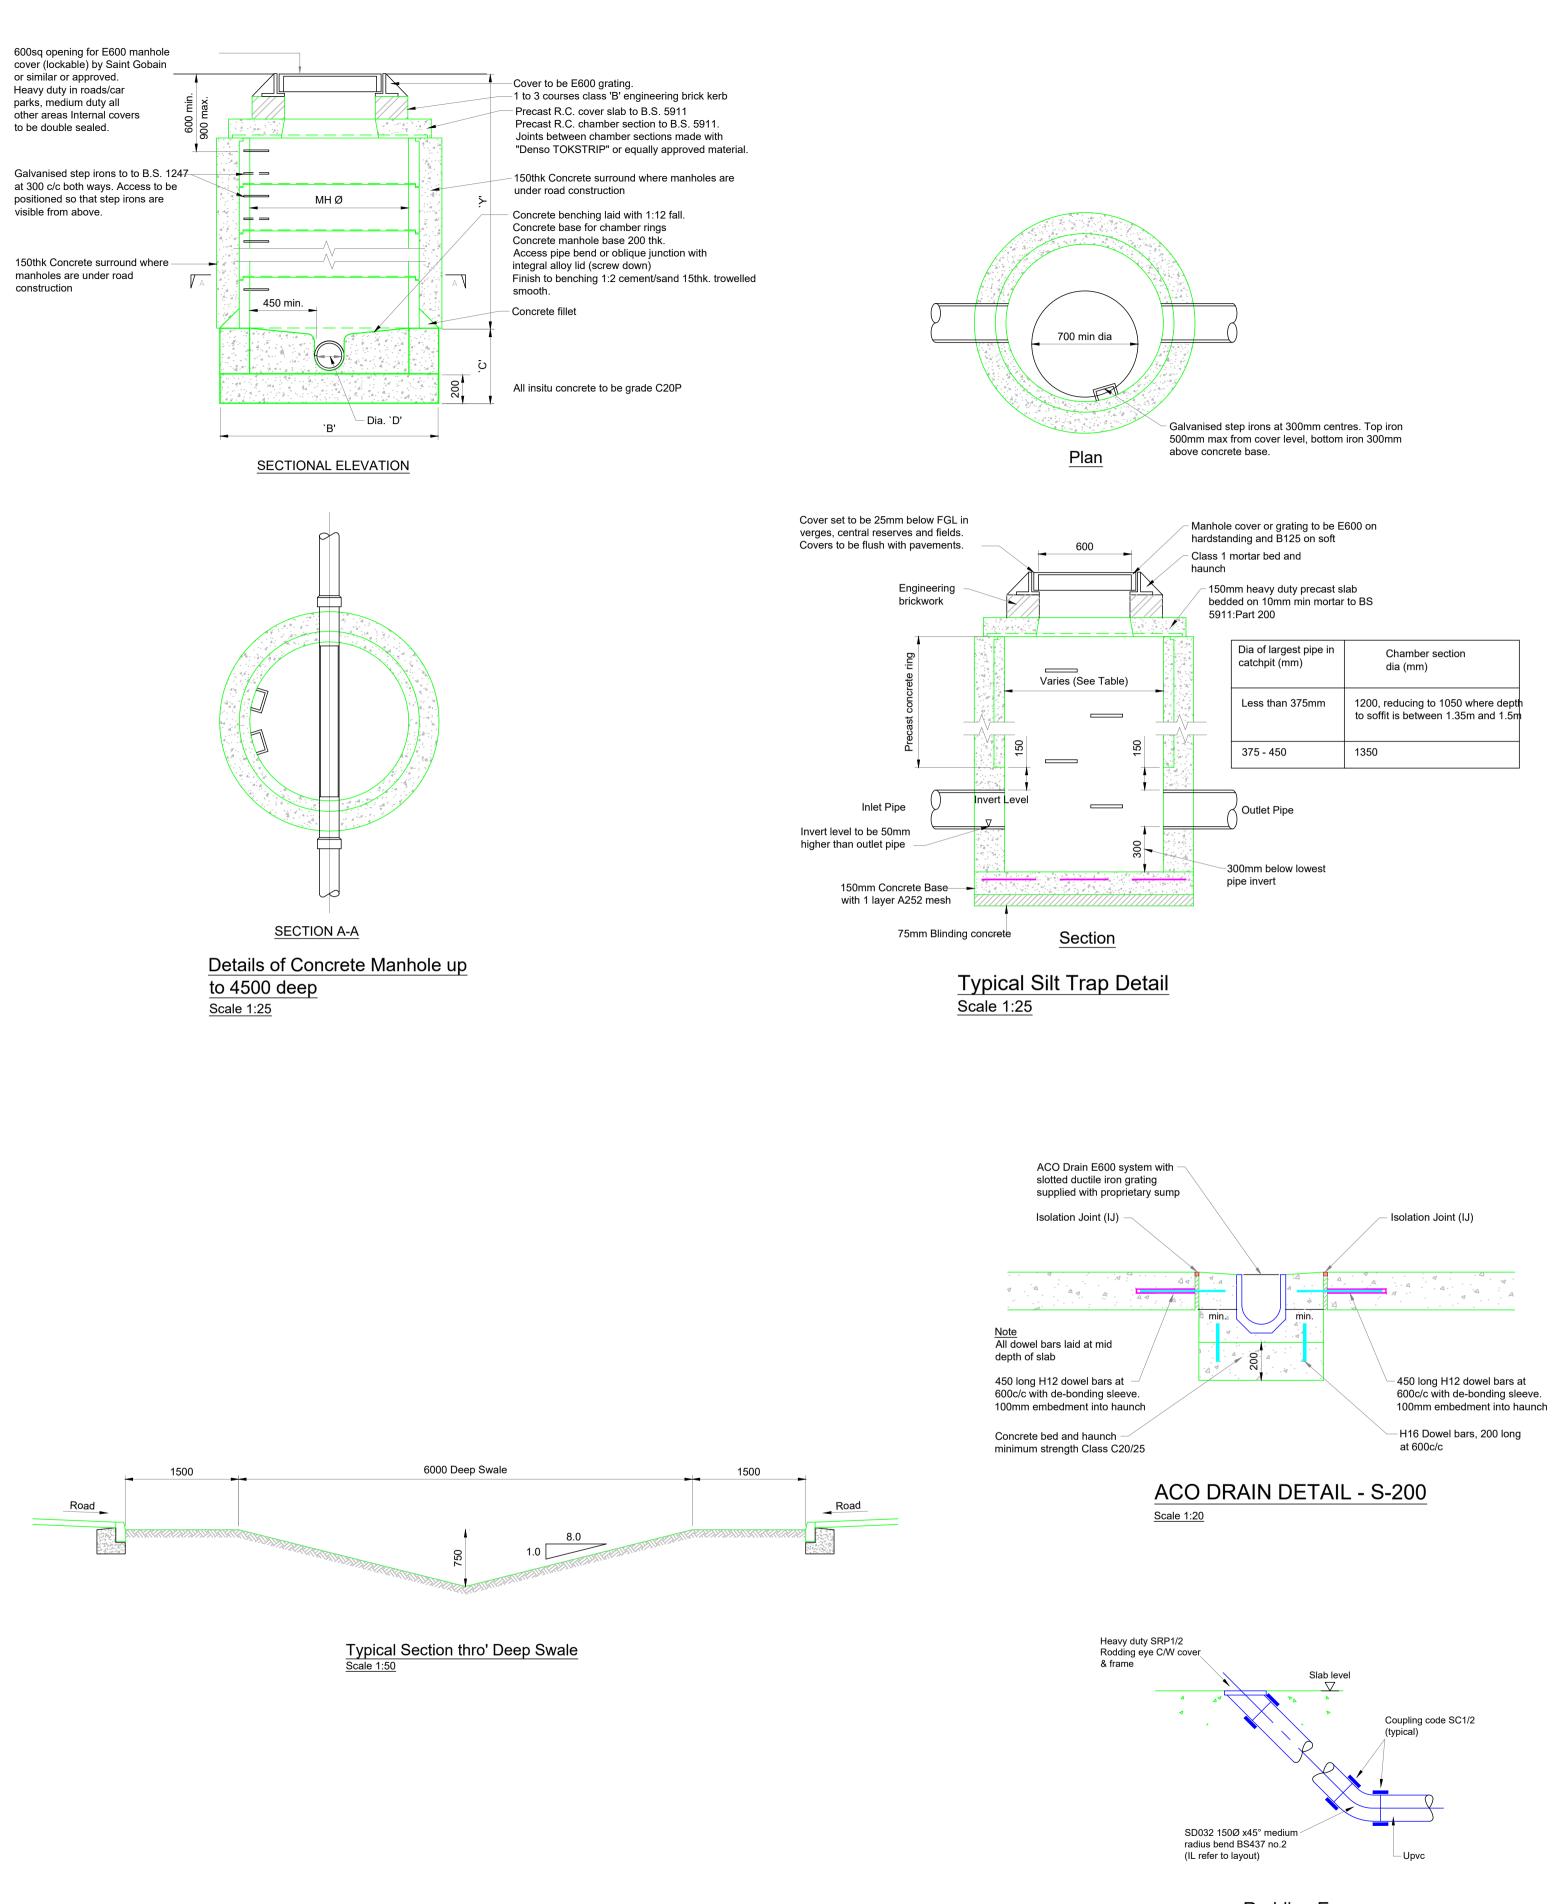



Rodding Eye Scale 1:25

1. Backfilling under roads and pavings: Backfill from top of granular bedding up to formation level with Granular Sub-base Material Type 1 to Highways Agency specification for Highway Works 1998 Clause 803, laid and compacted in 150mm layers.

2. Backfilling under landscaped areas: Backfill from top of granular bedding up to underside of top soil with selected Class 1Bfill whether selected from locally excavated material or imported, shall consist of uniform readily compactible material, free from vegetable matter, building rubbish and frozen material, or materials susceptible to spontaneous combustion, and excluding clay or liquid limit greater than 80 and/or plastic limit greater than 55 and materials of excessively high moisture content. Clay lumps and stones retained on 75mm and 37.5mm sieves respectively shall be excluded from the fill material. Laid and compacted in layers not exceeding 300mm.

3. Do not use heavy compactors before there is 600mm of material over pipe.

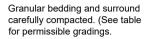

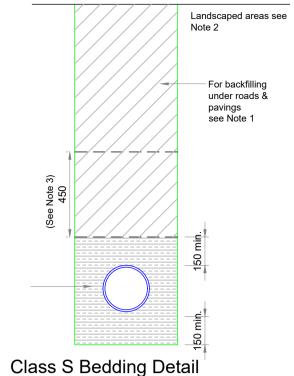

Scale 1:20

| Pipe | Maximum | Class of | Suitable Materials | |
|----------------------|-----------------------|----------|---|--|
| Nominal Bore (DN) | Particle Size (mm) | Bedding | Imported granular materials (Note a) | Maximum CF value for as-dug granular material (Note b) |
| | | S | | 0.15 |
| 100 | 10 | В | 10mm nominal single size. | 0.30 (Note c) |
| 100 | 10 | F | | 0.15 |
| | | Ν | Course medium or fine sand | |
| Over | | S | | 0.15 |
| 150 to | 20 | В | 14 to 5mm graded | 0.30 (Note c) |
| 500 | 20 | F | or 20mm to 5mm graded. | 0.15 |
| | | N | All in aggregate or course medium or fine sand. | |
| Over | | S | | 0.15 |
| 500 (Note d) | 40 | В | 14 to 5mm graded | 0.30 (Note c) |
| | 40 | F | or 20mm to 5mm graded or 40mm to 5mm graded. | 0.15 |
| | | N | Course medium or fine sand | |

Notes


a. Imported granular materials to include aggregates to BS 882 air cooled blast furnace slag to BS EN 12620 and sintered pulverized fuel ash to BS EN 13055. b. Compaction fraction value, see Appendix A.


c. The higher the CF value for as dug bedding and sidefill materials the greater the required effort for adequate compaction. d. Angular materials should be chosen to ensure sufficient support is provided to these heavier pipes. Crushed rock aggregates to BS 882 are

recommended. Air cooled blast furnace slag to BS 3797 or other granular materials may be used if they show a similar degree of angularity.

Revisions Drn. Date PLANNING DRAWING WHYTE & MACKAY INVERGORDON MATURATION WAREHOUSING TYPICAL CONSTRUCTION DETAILS SHEET 2 of 2 Scale: Drawn: Ck'd: STH AA AS SHOWN @ A1 Date: Date: DO NOT SCALE Nov '22 Nov '22 **BLYTH&BLYTH** Cornerstone, 60 South Gyle Crescent Edinburgh EH12 9EB Email: edinburgh@blythandblyth.co.uk www.blythandblyth.co.uk Telephone: 0131 474 270 Drawing No. Revisior EC22808:00:120 -

SECTION - (1) - LONGSECTION SCALE: H 1:1000,V 1:200. DATUM: 0.000 Ch 0.000 to Ch 310.000

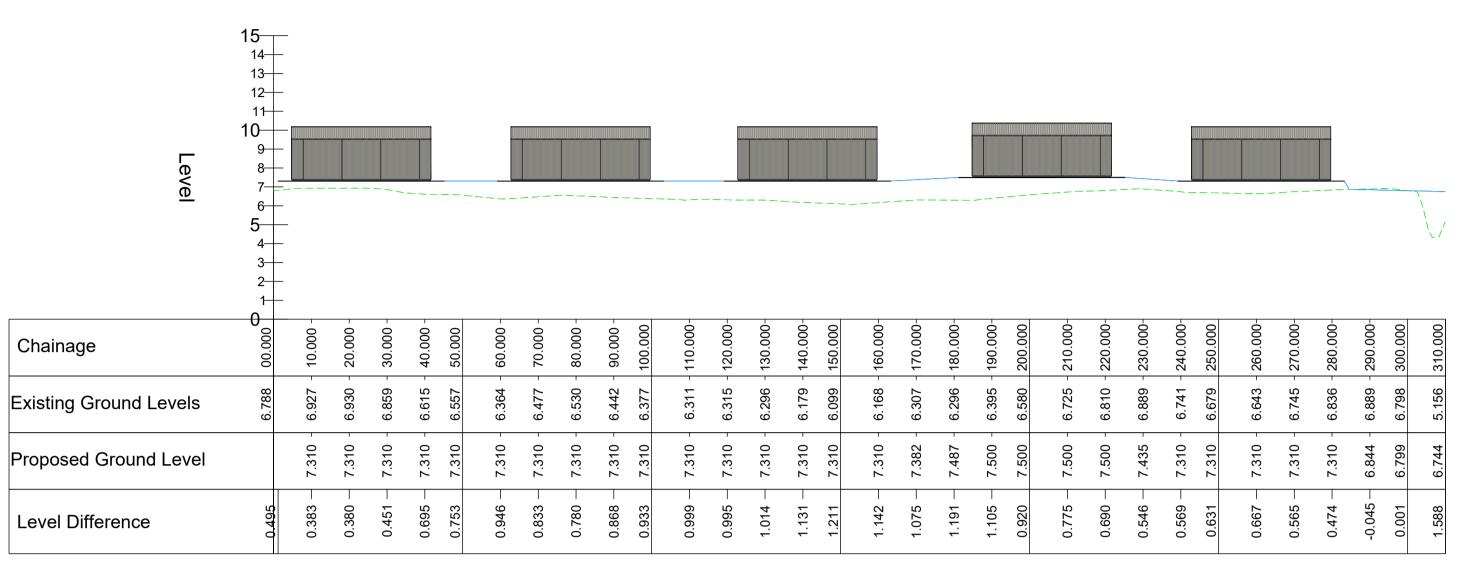

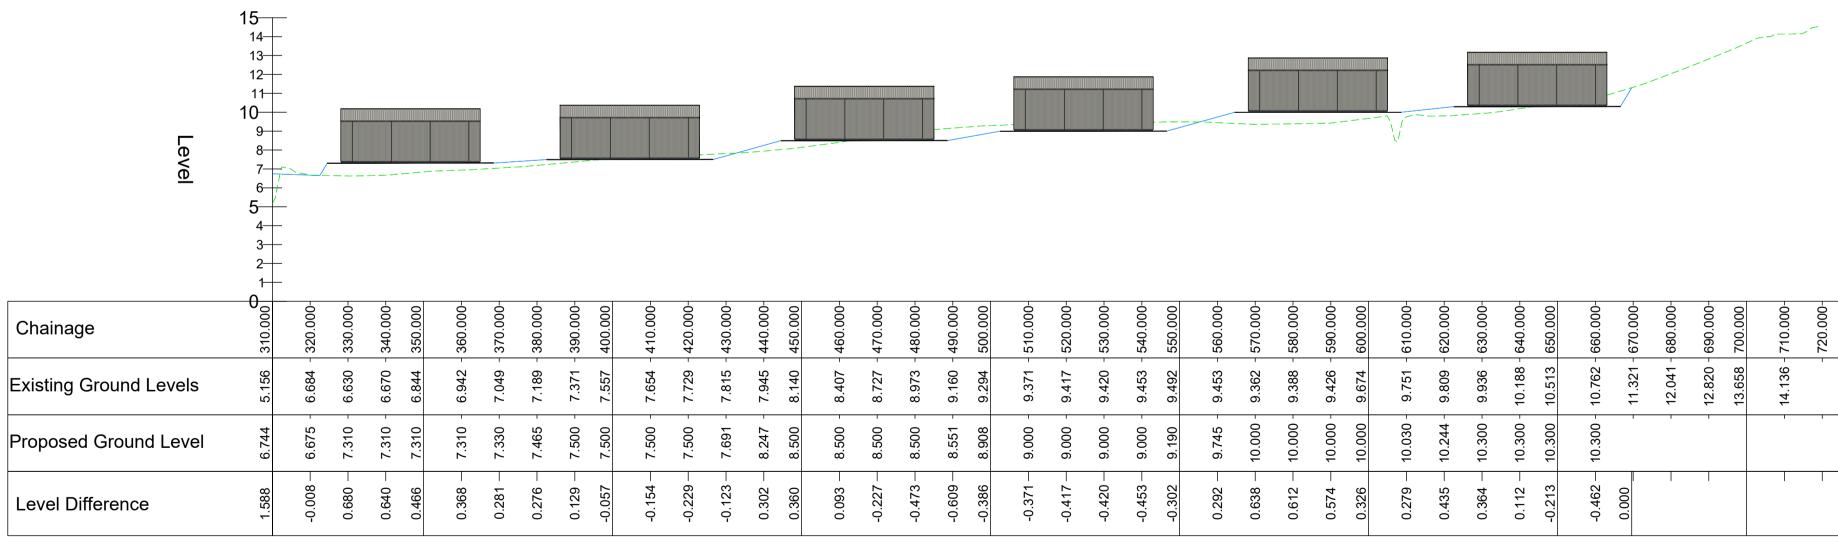

Notes

| 150.00 | 160.00 | 170.0(| 180.00 | 190.0(| 200.0 | 210.0 | 220.0 | 230.0 | 240.0 | 250.0 | 260.0 | 270.0 | 280.0 | 290.0 | 300.0 | 310.0 |
|--------|---------|---------|---------|---------|-------|---------|---------|---------|---------|-------|---------|---------|---------|---------|-------|-------|
| 6.099 | 6.168 - | 6.307 - | 6.296 - | 6.395 - | 6.580 | 6.725 - | 6.810 - | 6.889 - | 6.741 - | 6.679 | 6.643 - | 6.745 - | 6.836 - | 6.889 - | 6.798 | 5.156 |
| 7.310 | 7.310 - | 7.382 - | 7.487 - | 7.500 - | 7.500 | 7.500 - | 7.500 - | 7.435 - | 7.310 - | 7.310 | 7.310 - | 7.310 - | 7.310 - | 6.844 - | 6.799 | 6.744 |
| 1.211 | 1.142 — | 1.075 - | 1.191 – | 1.105 - | 0.920 | 0.775 | - 069.0 | 0.546 | 0.569 – | 0.631 | 0.667 - | 0.565 | 0.474 — | -0.045 | 0.001 | 1.588 |



SECTION - (1) - LONGSECTION CONTINUED SCALE: H 1:1000,V 1:200. DATUM: 0.000

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|------------|------------|------------|------------|---------|------------|------------|------------|------------|---------|------------|------------|------------|------------|---------|----------|-----------|------------|------------|---------|------------|------------|-----------------------|
| 9.371 | 9.417 | 9.420 | 9.453 | 9.492 | 9.453 | 9.362 | 9.388 | 9.426 | 9.674 | 9.751 | 9.809 | 9.936 | 10.188 | 10.513 | 10.762 | 11.321 | 12.041 | 12.820 | 13.658 | 14.136 | | |
| 9.000 - | 9.000 | 9.000 | 9.000 - | 9.190 | 9.745 - | 10.000 - | 10.000 - | 10.000 - | 10.000 | 10.030 - | 10.244 - | 10.300 - | 10.300 - | 10.300 | 10.300 - | I | I | | | 1 | I | |
| -0.371 | -0.417 | -0.420 | -0.453 — | -0.302 | 0.292 - | 0.638 - | 0.612 - | 0.574 - | 0.326 | 0.279 — | 0.435 — | 0.364 | 0.112 - | -0.213 | -0.462 | 0.000 | | | | | | |

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| | | | | | | WHYTE AND MACKAY |
| | | | | | | PLANNING |
| | | | | | | DRAWING |

| BLYTH&BLYTH |
|---|
| Cornerstone, 60 South Gyle Crescent Edinburgh EH12 9EB |

Email: edinburgh@blythandblyth.co.uk www.blythandblyth.co.uk Telephone: 0131 474 2700

INVERGORDON MATURATION WAREHOUSING

PROPOSED EARTHWORKS SECTIONS Sht 1 of 2

| Drawn: EMP | Ck'd _{AA} | Scale AS SHOWN @ A1 |
|---------------|--------------------|---------------------|
| Date: Nov '22 | Date: Nov '22 | DO NOT SCALE |
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| Drawing No. | | Revision |
| EC2280 | 8:00:110 | - |

| Level | 15 14- 13- 12- 11- 10- 9- 8- 7- 6- | | | | | | | | | | | | | | | | | | | | | | | | | | | | | | | | | | | | | | | | |
|---|
| Chainage | 5 000.00 | - 10.000 | 20.000 - | 30.000 - | 40.000 - 50.000 | - 000.09 | - 000.02 | 80.000 - | 90.000 - | | 110.000- | 120.000- | 130.000- | 140.000- | 150.000 | | 1,00,000- 180,000- | | 200.000 | 210.000- | 220.000- | 230.000- | 240.000- | 250.000 | 260.000- | 270.000- | 280.000- | 290.000- | 300.000 | 310.000- | 320.000- | 330.000- | 340.000- 350.000 | 360.000- | 370.000- | 380.000- | 390.000- | 400.000 | 410.000- | 420.000- | 430.000 |
| Existing Ground Levels | 10.391 | 10.397 - | 10.375 - | 10.506 - | 10.466 - 10.353 | 10.466 - | 10.500 - | 10.488 - | 10.408 - | | 10.362 - | 10.259 - | 10.269 - | 10.519 - | 10.593 - | 10 602 | - 200.01 | 10.663 - | 10.934 | 10.922 - | 10.969 - | 10.805 - | 10.754 - | | 10.654 - | 10.690 - | 10.619 - | 10.628 - | 10.647 | 10.654 - | 10.644 - | 10.637 - | 10.651 - | 10.696 - | 10.658 - | 10.852 - | 10.948 - | 10.848 | • | 11.210 - | |
| Proposed Ground Level | 000.6 | - 000.6 | - 000.6 | - 000.6 | 9.000 | - 000.6 | - 000.6 | - 000.6 | 9.000 | 9.000 | 9.173 - | 9.618 - | 9.800 | 9.800 | 9.800 | 700.0 | 9.020 | 10,000 - | 10.000 | 10.000 - | 10.000 - | 10.108 - | 10.386 - | | 10.500 - | 10.500 - | 10.500 - | 10.527 - | 10.670 | 10.700 - | 10.700 - | 10.700 - | 10.700 - 10.904 | 11.423 - | 11.500 - | 11.500 - | 11.500 - | | 1 | I | |
| Level Difference | -1.391 | -1.397 - | -1.375 | -1.506 - | -1.466 — -1.353 | -1.466 | -1.500 - | -1.488 | -1.408 - | 007.1- | -1.189 | -0.641 | -0.469 | -0.719 | -0.003 | 977.0 | -0.7.0- | - 20.0- - 668 - | -0.003 | -0.922 | -0.969 | - 269.0- | -0.368 - | -0.182 | -0.154 | -0.190 | -0.119 | -0.101 | 0.023 | 0.046 - | 0.056 - | 0.063 — | 0.068 | 0.727 — | 0.842 — | 0.648 | θ.468 – | | | | T |
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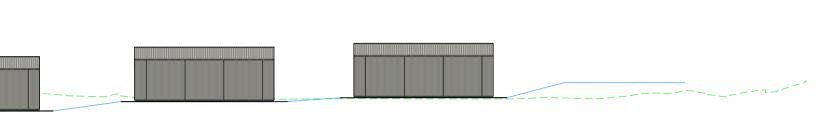


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| Revisions | Date | Drn. | Revisions | Date | Drn. | WHYTE AND MACKAY |

| 3 | | | | | | | 8 | | | | | <u></u> | | | | | 1 | | | | | | | | | | | | | | | | |
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| -00 | -00 | -000 | 00 | -00 | -00 | -00 | -00 | 00 | | -00 | -00 | -00 | 00 | -000 | -00 | -00 | -00 | 000 | -000 | -000 | -000 | -000 | 00 | -000 | -000 | -000 | -000 | 00 | -00 | -00 | -000 | -00 | 000. |
| 220.000 | 230.000 | 240.000 | 250.000 | 260.000 | 270.000 | 280.000 | 290.000 | 300.000 | 310.000 | 320.000 | 330.000 | 340.000 | 350.000 | 360.000 | 370.000 | 380.000 | 390.000 | 400.000 | 410.000 | 420.000 | 430.000 | 440.000 | 450.000 | 460.000 | 470.000 | 480.000 | 490.000 | 500.000 | 510.000 | 520.000 | 530.000 | 540.000 | 550.0 |
| 6.818 | 6.798 | 6.760 | 6.745 | 6.739 | 6.745 - | 6.759 | 6.737 | 6.754 | 6.776 | 6.805 | 6.832 | 6.869 | 6.953 | 7.019 | 6.925 | 7.103 - | 7.504 - | 8.507 | 9.734 | 10.502 - | 10.789 - | | 10./08 | 10.763 - | 11.051 - | 10.940 - | 10.901 - | 10.957 | 10.974 - | 10.823 - | 10.601 - | 10.434 - | 10.428 |
| 7.310 - | 7.310 - | 7.310 - | 7.310 | 7.310 - | 7.310 - | 7.310 - | 7.310 - | 7.310 | 7.310 - | 7.310 - | 7.310 - | 7.310 - | 7.310 | 7.310 - | 7.310 - | 7.310 - | 7.310 - | 7.451 | 7.631 - | 7.811 - | 7.987 - | 8.175 - | 8.363 | 8.552 - | 8.740 - | 8.928 - | 9.000 | 9.000 | - 000.6 | 9.000 - | - 000.6 | 9.000 - | 9.000 |
| 0.492 — | 0.512 - | 0.550 | 0.565 | 0.571 | 0.565 — | 0.551 — | 0.573 — | 0.556 | 0.534 - | 0.505 — | 0.478 — | 0.441 — | 0.357 | 0.291 | 0.385 | 0.207 — | -0.194 — | -1.056 | -2.103 - | -2.663 -2.692 — | -2.803 | -2.589 - | -2.345 | -2.211 | -2.312 | -2.012 | -1.901 - | -1.957 | -1.974 — | -1.823 — | -1.601 - | -1.434 — | -1.428 |


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| SECTION - (3) - LONGSECTION | | | | | | | | |
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SECTION - (2) - LONGSECTION SCALE: H 1:1000,V 1:200. DATUM: 5.000








INVERGORDON MATURATION WAREHOUSING

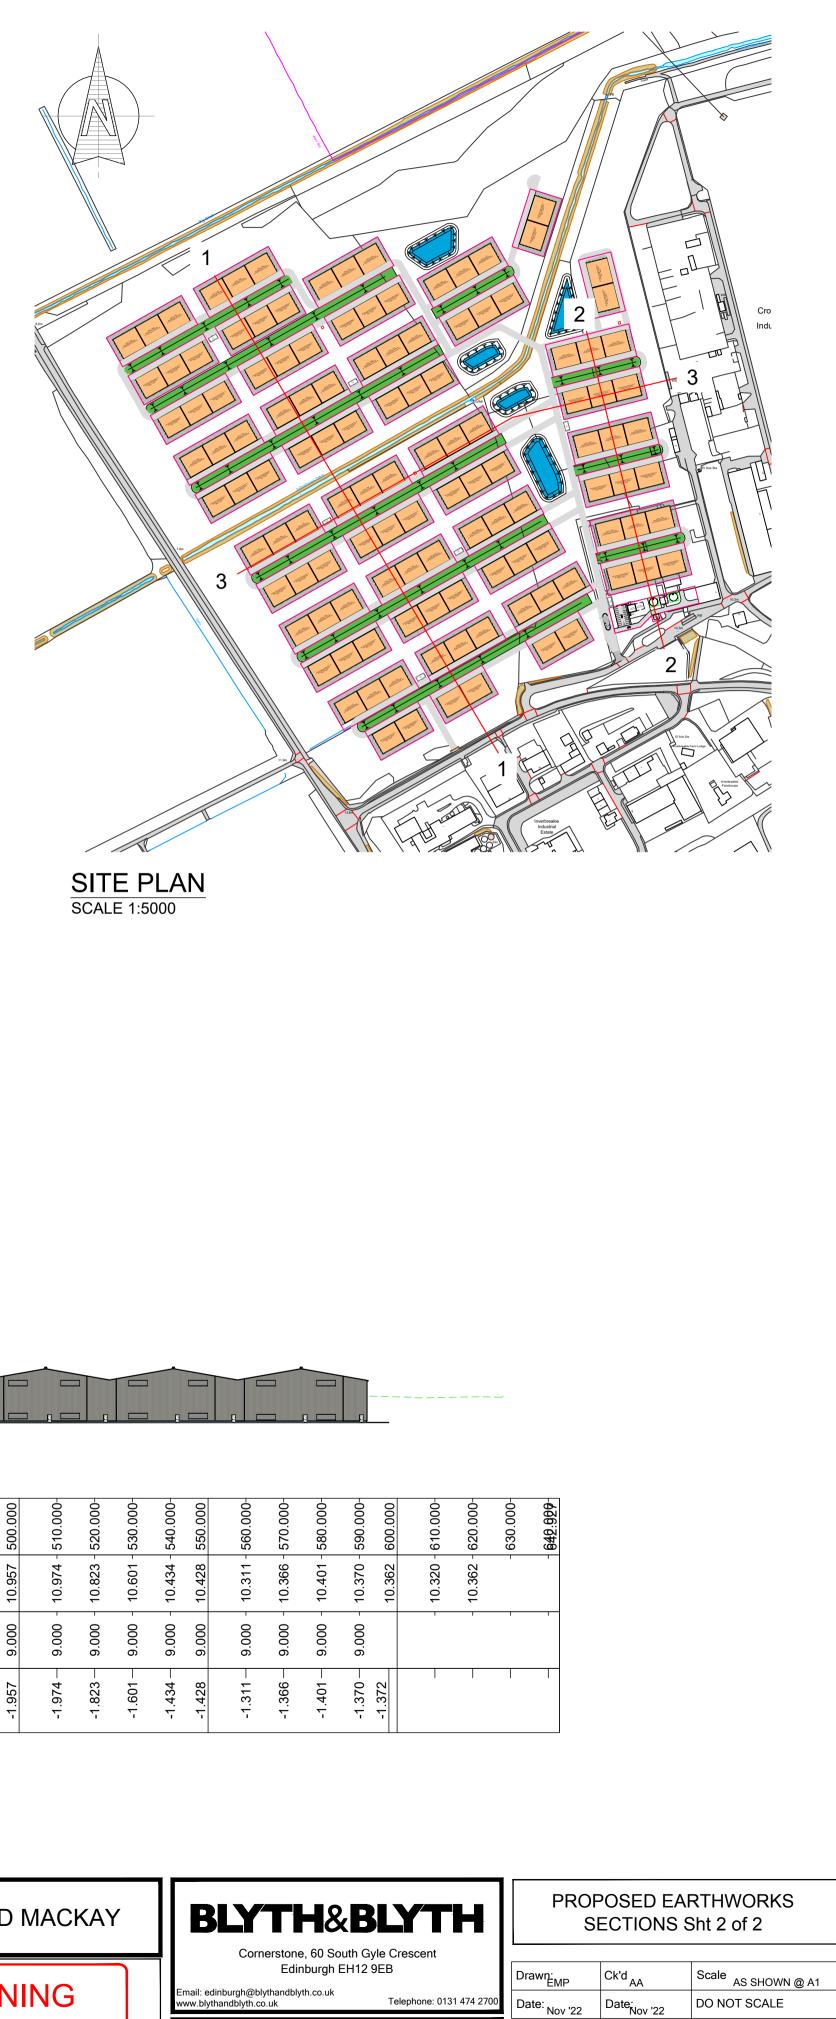DRAWING

Revision EC22808:00:111 -

Drawing No.

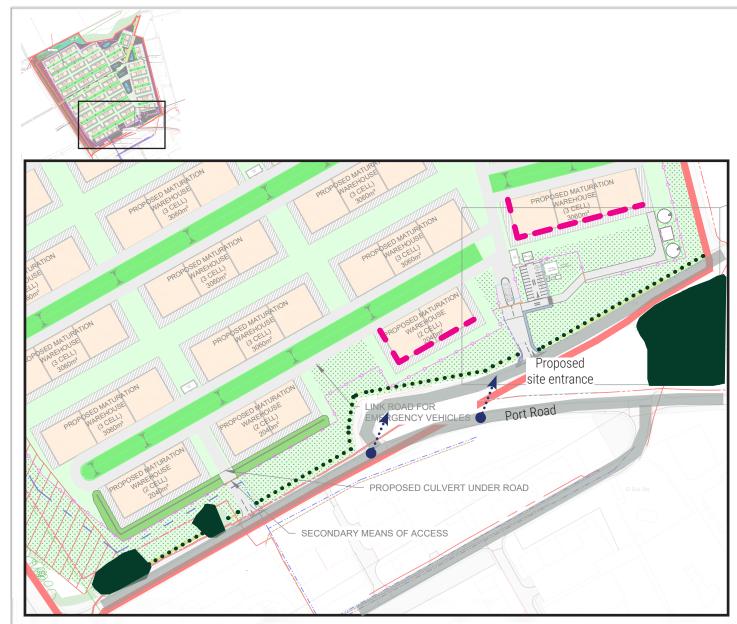

Key

- Facades subject to public art treatment (mural)
- ••• Hedgerow management to faciliate views
 - Existing stands of vegetation
- Views from Port Road

In response to feedback obtained through the public consultation process, it is proposed to incorporate public art on the facades of warehouses at the site entrance. Given the popularity of Port Road as part of a loop walk around Invergordon, and the proximity of the warehouses to publicly accessible elevated viewing locations, these facades are considered to provide a suitable opportunity to incorporate murals that will complement the wider collection of mural artworks within the town.

The visual appearance and thematic content is subject to further creative development, but the design will consider a colour palette that complements the proposed warehouse scheme, and the agricultural backdrop to the views here.

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| LANDERAPE ARCHITECTURE / LABAN DESIGN / "LANNING | | | 100 | | | (pinjert) | Cromarty Maturation Warehousing | | | | |
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| tilt as at www.paulhopath.com Ind us on: facebook J twitter J instagram J linkeder | from Didnance Survey material © Crown copyright 2018 Licence Number 180824805 | | | | | status | PLANNING | ì | | | |



| Mix of All tra at 2m *tree Layou less t | ees to be planted to be f centres s to be positioned to fro it - All planting blocks to han 3 or more than 7 of | trees (depending on availal itted with 1500mm tree she | | s planted | | |
|---|---|---|---|--|--|--|
| at 2m *tree Layou less t are a Meac 15% | centres s to be positioned to fro ut - All planting blocks to han 3 or more than 7 of | nt 3m edge of planting | iters. Tree | s planted | | |
| Layor less t are a Meac 15% | it - All planting blocks to han 3 or more than 7 of | | | | | |
| less t are a Meac 15% | han 3 or more than 7 of | o nave feathered edge with r | | C C | | |
| 15% | ···· ··· ··· | the same species, ensuring on. Tree blocks to be seeded | that no thr | ee plants | | |
| | ow mix. | | | | | |
| 25% | Alnus glutinosa | 1 + 2 Transplant, BR | 40-60 ht | t | | |
| | Betula pubescens | 1 + 2 Transplant, BR | 60-80 ht | | | |
| 10% | Crataegus monogyna | 1 + 2 Transplant, BR | 40-60 ht | | | |
| 5% 15% | Prunus spinosa* Acer campestre | 1 + 2 Transplant, BR 1 + 2 Transplant, BR | 40-60 ht 60-80 ht | | | |
| 15% | Pinus sylvestris | 1 + 1 Transplant, BR | 60-80 ht | | | |
| 5% | Populus tremula | 1 + 1 Transplant, BR | 60-80 ht | i | | |
| 5% | Corylus avellana* | 1 + 2 Transplant, BR | 40-60 ht | t | | |
| 5% | Viburnum opulus* | 1 + 2 Transplant, BR | 40-60 hi | i - | | |
| WOO | | AI TEDNATIVE MIX - wot ar | ound only | | | |
| 50% | Alnus glutinosa | 1 + 1 Transplant, BR | | : | | |
| 20% | Salix aurita | 1 + 1 Transplant, BR | 40 -60 h | t | | |
| 30% | Salix cinerea | 1 + 1 Transplant, BR | 40 -60 h | t | | |
| | OSED HEDGEROW PLAN | NTING | | | | |
| Hedg | erow protection:- 900mr | | ing guard s | secured with | | |
| 5 | | e row) | | | | |
| 15% | Acer campestre | 90/120cm ht, 1+1 | BR 13 | / ImHedgerow | | |
| 15% | Betula pendula | 60/90cm ht, 1+1 | BR 13 | / ImHedgerow | | |
| | • | 90/120cm ht, 1+1 | | / ImHedgerow | | |
| | • • | | | / ImHedgerow | | |
| | | | | / ImHedgerow / ImHedgerow | | |
| | · | 40/60cm ht, 0+1 | | / ImHedgerow | | |
| 5% R | osa rugosa 'Rubra', | 40/60cm ht, 0+1 | BR 13 | / ImHedgerow | | |
| 10% \ | /iburnum opulus | 60/90cm ht, 1+1 | BR 13 | / ImHedgerow | | |
| All tr | ees to be planted to be f | itted with 1200mm spiral gu | ards with s | single supporting | | |
| | | | DD | | | |
| | - | | | | | |
| | | 50% 4-6cm 50% 6-8cm | BR | | | |
| SCRU | B PLANTING MIX | | | | | |
| Mix o | f bare root or cell grown | n material (depending on ava | ilability) | | | |
| | • | itted with 1500mm tree she | lters. Shrul | os to be planted | | |
| | | planting block | | | | |
| 5% | Alnus glutinosa* | 1 + 2 Transplant, BR | 40-60 ht | | | |
| 5% | Betula pubescens* | 1 + 2 Transplant, BR | 60-80 ht | | | |
| 5% | Crataegus monogyna* | 1 + 2 Transplant, BR | 40-60 ht | | | |
| 20% | Prunus spinosa | 1 + 2 Transplant, BR | | | | |
| 5% | Acer campestre* | 1 + 2 Transplant, BR | | | | |
| | • | • | | | | |
| | | • | | | | |
| 20% | | | 40 00 m | 1 | | |
| | | | | | | |
| Wet M | Seed Mix to Damp Ground / Swale Base Wet Meadow Mix by Scotia Seeds to SUDS floor and wetland areas. Area seeded at 3-5g per m2 | | | | | |
| | | | | | | |
| North | ern Hav Meadow | | | | | |
| (Nort addit | ern Hay Meadow hern Hay Meadow mix by onal species (<i>Rhinanthu</i> lination with project Eco | <i>is minor</i>) to be added in | | | | |
| (Nort addit coord | nern Hay Meadow mix by | <i>is minor</i>) to be added in logist). | | | | |
| | 5% 5% 5% 5% 10% 20% 30% 20% 30% 10% 25% 10% 25% 10% 25% 10% 25% 10% 25% 10% 25% 10% 25% 5% 7% 10% 25% 10% 20% <td>5%Corylus avellana*5%Viburnum opulus*5%Viburnum opulus*WOODLAND TREE PLANTING 50%Alnus glutinosa 20%20%Salix aurita 30%Salix cinereaImage: Species mix 2 (2m width triple 15% Acer campestre 15% Betula pendula 10% Corylus avellana 25% Crataegus monogyma 10% Euonymus europaeus 5% Prunus spinosa 5% Rosa rugosa 'Alba', 5% Rosa rugosa</td> <td>5% Corylus avellana* 1 + 2 Transplant, BR 5% Viburnum opulus* 1 + 2 Transplant, BR 5% Viburnum opulus* 1 + 1 Transplant, BR 20% Salix aurita 1 + 1 Transplant, BR 20% Salix cinerea 1 + 1 Transplant, BR 30% Salix cinerea 0/120cm ht, 1 + 1 15% Acer campestre 90/120cm ht, 1 + 1 10% Longwaus europaeus 60/90cm ht, 1 + 1 10% Fortaaegus monogyma 60/90cm ht, 0 + 1 10% Niburnum opulus 60/90cm ht, 1 + 1 10% Niburunum opulus</td> <td>5% Corylus avellana* 1 + 2 Transplant, BR 40-60 ht 5% Viburnum opulus* 1 + 2 Transplant, BR 40-60 ht 5% Alnus glutinosa 1 + 1 Transplant, BR 60-60 ht 20% Salix aurita 1 + 1 Transplant, BR 40-60 ht 30% Salix cinerea 1 + 1 Transplant, BR 40-60 ht 30% Salix cinerea 1 + 1 Transplant, BR 40-60 ht 30% Salix cinerea 1 + 1 Transplant, BR 40-60 ht 30% Salix cinerea 1 + 1 Transplant, BR 40-60 ht 30% Salix cinerea 1 + 1 Transplant, BR 40-60 ht 30% Salix cinerea 1 + 1 Transplant, BR 40-60 ht 30% Salix cinerea 0/120cm ht, 1+1 BR 13 15% Acer campestre 90/120cm ht, 1+1 BR 13 10% Corylus avellana 90/120cm ht, 1+1 BR 13 10% Euonymus europaeus 60/90cm ht, 1+1 BR 13 10% Euonymus europaeus 60/90cm ht, 1+1 BR 13 5% Rosa rugosa 'Rubra', 40/60cm ht, 0+1 BR 13 <tr< td=""></tr<></td> | 5%Corylus avellana*5%Viburnum opulus*5%Viburnum opulus*WOODLAND TREE PLANTING 50%Alnus glutinosa 20%20%Salix aurita 30%Salix cinereaImage: Species mix 2 (2m width triple 15% Acer campestre 15% Betula pendula 10% Corylus avellana 25% Crataegus monogyma 10% Euonymus europaeus 5% Prunus spinosa 5% Rosa rugosa 'Alba', 5% Rosa rugosa | 5% Corylus avellana* 1 + 2 Transplant, BR 5% Viburnum opulus* 1 + 2 Transplant, BR 5% Viburnum opulus* 1 + 1 Transplant, BR 20% Salix aurita 1 + 1 Transplant, BR 20% Salix cinerea 1 + 1 Transplant, BR 30% Salix cinerea 0/120cm ht, 1 + 1 15% Acer campestre 90/120cm ht, 1 + 1 10% Longwaus europaeus 60/90cm ht, 1 + 1 10% Fortaaegus monogyma 60/90cm ht, 0 + 1 10% Niburnum opulus 60/90cm ht, 1 + 1 10% Niburunum opulus | 5% Corylus avellana* 1 + 2 Transplant, BR 40-60 ht 5% Viburnum opulus* 1 + 2 Transplant, BR 40-60 ht 5% Alnus glutinosa 1 + 1 Transplant, BR 60-60 ht 20% Salix aurita 1 + 1 Transplant, BR 40-60 ht 30% Salix cinerea 1 + 1 Transplant, BR 40-60 ht 30% Salix cinerea 1 + 1 Transplant, BR 40-60 ht 30% Salix cinerea 1 + 1 Transplant, BR 40-60 ht 30% Salix cinerea 1 + 1 Transplant, BR 40-60 ht 30% Salix cinerea 1 + 1 Transplant, BR 40-60 ht 30% Salix cinerea 1 + 1 Transplant, BR 40-60 ht 30% Salix cinerea 0/120cm ht, 1+1 BR 13 15% Acer campestre 90/120cm ht, 1+1 BR 13 10% Corylus avellana 90/120cm ht, 1+1 BR 13 10% Euonymus europaeus 60/90cm ht, 1+1 BR 13 10% Euonymus europaeus 60/90cm ht, 1+1 BR 13 5% Rosa rugosa 'Rubra', 40/60cm ht, 0+1 BR 13 <tr< td=""></tr<> | | |

| Do not scale from drawing, use figured dimensions only. |
|--|
| All dimensions are to be checked on site by contractor prior to commencement of all work. |
| Discrepancies should be reported immediately. |
| This drawing is to be read in conjunction with all other TPHC drawings and specification. |
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revision description

01 Minor Layout Revision



1/11/22 NH

| LANDSCAPE ARCHITECTURE / URBAN DESIGN / PLANNING | | | | | | | | | | | | | | |
|---|---|--------|-------|-----------------|------------|--|------------|--------|--|--|--|--|--|---|
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| created | 10/1 | 1/2022 | drawn | NH | checked MS | | scale @ A0 | 1:1000 | | | | | | |
| project number 1519 draw | | | | ving number 101 | | | revision | 01 | | | | | | |
| client | Whyte and Mackay | | | | | | | | | | | | | |
| project | Cromarty Maturation Warehousing | | | | | | | | | | | | | |
| drawing | Landscape Layout Plan | | | | | | | | | | | | | |
| status | PLA | ANNIN | G | | | | | | | | | | | |

